

ACTIVITY DETERMINATION

Project No. BGYHY

Conflict of Interest¹

In this matter:

Signed...

- 1. I have declared any possible conflict of interests (real, potential or perceived) to the Acting Chief Executive, Land & Housing Corporation.
- 2. I do not consider I have any personal interests that would affect my professional judgement.
- 3. I will inform the Acting Chief Executive, Land & Housing Corporation as soon as I become aware of a possible conflict of interest.

Emma Nicholson

Dated....24 August 2023

Having regard to the Determination Recommendation Report, the Statement of Compliance and the Review of Environmental Factors for this project addressing matters under Part 5 of the *Environmental Planning and Assessment Act 1979,* I determine that the activity proceed as described below and subject to the identified requirements set out in **Schedule 1**.

SITE IDENTIFICATION		
STREET ADDRESS		
Unit/Street No	Street or property name	
18-22	Mundamatta Street	
Suburb, town or locality		Postcode
Villawood, NSW		2163
Local Government Area(s)	Real property description (Lot a	nd DP)
Canterbury Bankstown	Lots 814, 815 & 816 in DP 36608	3
ACTIVITY DESCRIPTION		
Provide a description of the activity	V	

Demolition of existing dwellings and structures, removal of trees, and the construction of a seniors housing development comprising of 12 independent living seniors housing units (7 x 1 bedroom and 5 x 2 bedroom units) with associated landscaping and fencing, surface parking for 6 cars, consolidation of 3 lots into a single lot and construction of a stormwater drainage pipeline and easement over Lot 807 DP 36608, No. 82 Lowana Street.

1. Conflict of interest includes actual and potential. A conflict of interest includes pecuniary i.e. financial interests to you or a related party or non-pecuniary i.e. benefits to relatives, friends, business associates and personal causes, etc. This includes "related persons" as defined in the Property, Stock and Business Agency Act 2002.

lela Signed.....

Dated...24.August 2023

Emma Nicholson A/Head of Policy and Innovation Land and Housing Corporation Department of Planning & Environment

SCHEDULE 1

IDENTIFIED REQUIREMENTS

PART A – Standard Identified Requirements

THE DEVELOPMENT

The following identified requirements are to ensure that the **seniors housing** activity is carried out in accordance with the plans / documents and any amendments arising from the Review of Environmental Factors under Part 5 of the Environmental Planning & Assessment Act 1979, Section 171 of the Environmental Planning and Assessment Regulation 2021 and the requirements of State Environmental Planning Policy (Housing) 2021

1. The development shall be carried out substantially in accordance with the following plans / documents and as modified below by any of the undermentioned Identified Requirements:

Title / Name:	Drawing No. / Document Ref:	Revision / Issue:	Date [dd mm yyyy]:	Prepared by:
Architectural – Appendix A				
Coversheet	DA-0.00	8	14 February 2023	Custance
Site Analysis	DA-0.11	8	17 November 2022	Custance
Site Analysis	DA-0.12	7	17 November 2022	Custance
Site Plan	DA-0.20	9	22 November 2022	Custance
GA – Ground	DA-1.20	12	14 February 2023	Custance
GA – Level 1	DA-1.21	9	17 November 2022	Custance
GA - Roof	DA-1.22	8	17 November 2022	Custance
Shadow Diagrams	DA-1.65	7	17 November 2022	Custance
Shadow Diagrams	DA-1.66	7	17 November 2022	Custance
Eyes from the Sun	DA-1.68	4	17 November 2022	Custance
Eyes from the Sun	DA-1.69	4	17 November 2022	Custance

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Title / Name:	Drawing No. / Document Ref:	Revision / Issue:	Date [dd mm yyyy]:	Prepared by:
Eyes from the Sun	DA-1.70	4	17 November 2022	Custance
External Elevations	DA-3.00	8	14 February 2023	Custance
Building Sections	DA-4.00	7	17 November 2022	Custance
3D Images & Streetscape Elevation	DA-6.00	7	17 November 2022	Custance
Area Calculations	DA-11.00	7	17 November 2022	Custance
Landscape Set - Appendix B				
Cover Sheet	LAOO	-	26 August 2022	Taylor Brammer Landscape Architects
Ground Floor Landscape Plan	LA01	F	25 November 2022	Taylor Brammer Landscape Architects
Existing Tree Retained and Removed	LA02	F	25 November 2022	Taylor Brammer Landscape Architects
Landscape Details	LD01	A	15 September 2022	Taylor Brammer Landscape Architects
Landscape Details	LD02	В	21 October 2022	Taylor Brammer Landscape Architects
Environmental Site Manageme	nt – Appendix U			
Notes & Legend	ESM1	4	14 November 2022	JN Engineering Consultants
Typical Details	ESM2	4	14 November 2022	JN Engineering Consultants
ESM Site Plan	ESM3	6	31 January 2023	JN Engineering Consultants
Stormwater Services - Append	<u>dix C</u>			
Notes & Legend	C001	4	14 November 2022	JN Engineering Consultants
Site Plan	C010	6	14 November 2022	JN Engineering Consultants
Typical Details	C050	7	31 January 2023	JN Engineering Consultants

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Title / Name:	Drawing No. / Document Ref:	Revision / Issue:	Date [dd mm yyyy]:	Prepared by:
OSD Details	C051	1	31 January 2023	JN Engineering Consultants
Ground Stormwater Plan	C200	9	31 January 2023	JN Engineering Consultants
Level 1 Stormwater Plan	C210	4	14 November 2022	JN Engineering Consultants
Roof Stormwater Plan	C300	2	14 November 2022	JN Engineering Consultants
Survey – Appendix D and T				
Detail and Level Survey	S Sheet 1 / 11	-	04 December 2021	Norton Survey Partners
Mechanical Spatial - Appendix	<u>(A</u>			
Mechanical Concept 1 / Cover Page	DA-0.00	1	23 June 2022	Knox Advanced Engineering
Mechanical Concept 1 / GA– Ground	DA-1.20	1	23 June 2022	Knox Advanced Engineering
Mechanical Concept 1 / GA– Level 1	DA-1.21	1	23 June 2022	Knox Advanced Engineering
BASIX and NatHERS - Append	lix K and N			
BASIX Certificate	1318442M	02	18 May 2023	JN Engineering Consultants
NatHERS Certificate	0008210200	-	18 May 2023	Gradwell Consulting
Arboricultural Plans - Append	ix J			
Cover Sheet	T-00	А	14 February 2023	Arterra Design
Tree Retention Value Plan	T-01	В	14 February 2023	Arterra Design
Tree Protection and Removal Plan	T-02	В	14 February 2023	Arterra Design
Tree Protection Specifications	T-03	A	14 November 2022	Arterra Design
Specialist Reports				
Arboricultural Impact Assessment – Appendix J	AIA-01	В	14 February 2023	Arterra Design
Access Report – Appendix H	21353-DA	1.2	22 November 2022	Access-I
BCA Design Compliance Assessment – Appendix L	P220195	0	14 November 2022	BCA Vision

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Title / Name:	Drawing No. / Document Ref:	Revision / Issue:	Date [dd mm yyyy]:	Prepared by:
Noise Intrusion Assessment – Appendix V	20221154.2/09 11A/R0/ANP	0	9 November 2022	Acoustic Logic
Geotechnical Investigation Assessment – Appendix P	21/3539	0	December 2021	STS Geotechnics
Traffic Impact Assessment – Appendix S	21.640r01	v02	11 November 2022	TRAFFIX
Waste Management Plan – Demolition and Construction Waste – Appendix R	-	-	-	LAHC
Waste Management Plan – Occupancy Stage – Appendix R	-	-	-	LAHC

- 2. All building work is to be undertaken in accordance with the National Construction Code and referenced Australian Standards.
- 3. All commitments listed in the BASIX certificate and stamped plans shall be implemented.
- 4. All construction documentation and building work are to be certified in accordance with Section 6.28 of the *Environmental Planning and Assessment Act* 1979.
- 5. The land the subject of this determination shall be consolidated into a single lot. The plan of consolidation shall be lodged at the NSW Land Registry Services and shall be registered prior to the occupation of the development. A copy of the registered plan shall be provided to the Land & Housing Corporation.

OPERATIONAL MATTERS

The following Identified Requirements relate to the use of the site and are to ensure that the activity and its operation do not interfere with the amenity of the surrounding area.

Stormwater Run-off

- 6. Stormwater shall be collected within the site and conveyed in a pipeline to the appropriate gutter or drain under the control of the City of Canterbury Bankstown Council substantially in accordance with the approved concept stormwater drainage plans.
- 7. Alterations to the natural surface contours or surface absorption characteristics of the site shall not impede, increase or divert natural surface water runoff so as to cause a nuisance to adjoining property owners.
- 8. All driveways shall be graded in such a manner as to provide continuous surface drainage flow paths to the appropriate points of discharge.
- 9. To prevent water from entering buildings, surface waters shall be collected and diverted clear of the buildings by a sub-surface / surface drainage system.

Vehicular Access & Parking

- 10. Concrete vehicular crossings and laybacks shall be provided at the entrances/exits to the property. The crossings and laybacks shall be constructed in accordance with the City of Canterbury Bankstown Council's standard requirements for residential crossings. Council shall be provided with plans for the crossings and laybacks together with the payment of any Council inspection fees.
- 11. Particular care shall be taken in the location of vehicular crossings and/or laybacks to avoid poles, pits etc. The cost of any necessary adjustments to utility mains and services associated with the construction of the laybacks/driveways shall be borne by the Land & Housing Corporation. Obsolete gutter laybacks shall be constructed as kerb in accordance with the City of Canterbury Bankstown Council's standards.

Note: It is recommended that discussions be held with the relevant authorities before construction works commence.

12. Car parking spaces and driveways shall be constructed of concrete or other approved hard surface materials, **except** for permeable paving to be used in areas indicated in the Tree Protection and Removal Plan T-02 (Revision B), in the Arboricultural Impact Assessment Report dated 14 February 2023, prepared by Arterra Design. The car parking spaces must be clear of obstructions and columns, permanently line marked and provided with adequate manoeuvring facilities. The design of these spaces must comply with AS 2890.1.

Site Works

- 13. All soil erosion and sediment control measures required to be put in place prior to the commencement of demolition / construction works shall be maintained during the entire period of the works and until all the disturbed areas are restored by turfing, paving or revegetation. Soil erosion and sediment control measures shall be designed in accordance with the guidelines set out in the Blue Book *Managing Urban Stormwater: Soils and Construction* (4th edition, Landcom, 2004).
- 14. An appropriately qualified person shall design any retaining walls or other methods necessary to prevent the movement of excavated or filled ground, including associated stormwater drainage measures.

Building Siting

15. All buildings shall be sited well clear of any easements affecting the site. The builder shall ascertain if any easements do exist and, and if they do, obtain full details of such prior to construction commencing.

Smoke Detection System(s)

- 16. Smoke detection systems shall be installed throughout the building in accordance with requirements of Clause E2.2a of the Building Code of Australia. Detectors and alarms shall comply with AS 3786 and AS 1670 and must be:
 - i. connected to a permanent 240V power supply; and
 - ii. provided with a battery backup to activate the alarm unit in the event of failure of the permanent power supply.

Site Soil Contamination

17. If the site is identified as being potentially affected by soil contamination, it shall be inspected by a suitably qualified person to identify any contaminated or hazardous material present. A proposal for remediation shall be prepared, which may include preparation of a Remedial Action Plan, and remediation shall be carried out in accordance with the proposal. A Validation Report, prepared in accordance with Environment Protection Authority requirements, shall be obtained from a qualified expert on completion of the remediation work to verify that the site is suitable for the intended residential use. A copy of the Validation Report shall be provided to the Land & Housing Corporation on completion of the remediation works.

Landscaping

- 18. Landscaping shall be carried out substantially in accordance with the approved landscape plan(s) and maintained for a period of 12 months by the building contractor. The City of Canterbury Bankstown Council shall be consulted in relation to the planting of any street trees.
- 19. All scheduled plant stock shall be pre-ordered prior to commencement of construction or 3 months prior to the commencement of landscape construction works, whichever occurs sooner, for the supply to the site on time for installation. The builder shall provide written confirmation of the order to the Land & Housing Corporation.

Tree Removal

20. Removal of trees within the boundaries of the site and adjoining sites is to be carried out in accordance with the trees shown for removal on the approved Landscape Plan and Arboricultural Impact Assessment Report and no other trees shall be removed without further approval(s).

Fencing

21. All front fencing and gates shall be constructed wholly within the boundaries of the site. Any gates associated with the fencing shall swing inwards towards the site.

Provision of Letterbox Facilities

22. Suitable letterbox facilities shall be provided in accordance with Australia Post specifications.

Public Liability Insurance

23. A valid public liability insurance policy of at least \$10M shall be maintained throughout the demolition / construction works by the building contractor.

PRIOR TO ANY WORK COMMENCING ON THE SITE

The following Identified Requirements are to be complied with prior to any work commencing on the site, including demolition.

Disconnection of Services

24. All services that are required to be disconnected shall be appropriately disconnected and made safe prior to commencement of the demolition / construction works. The

various service authorities shall be consulted regarding their requirements for the disconnection of services.

25. All existing services within the boundary to remain live shall be identified, pegged and made safe.

Demolition

- 26. The builder shall notify the occupants of premises on either side, opposite and at the rear of the site a minimum of two days prior to demolition. Such notification shall be clearly written on an A4 size paper giving the date demolition will commence and be placed in the letterbox of every premise (including every unit in a multi-unit residential building or mixed use building). The demolition shall not commence prior to the date that is stated in the notice letter.
- 27. Prior to the demolition, a Work Plan shall be prepared by a competent person(s) in accordance with AS 2601 and shall be submitted to the Land & Housing Corporation. The Work Plan shall outline the identification of any hazardous materials (including surfaces coated with lead paint), method of demolition, the precautions to be employed to minimise any dust nuisance and the disposal methods for hazardous materials.
- 28. If buildings to be demolished are determined as, or suspected of, containing asbestos cement, a standard commercially manufactured sign containing the words 'DANGER ASBESTOS REMOVAL IN PROGRESS', and measuring not less than 400mm x 300mm, shall be erected in a prominent visible position on the site for the duration of the demolition works.

Note: Any buildings constructed before 1987 is assumed to contain asbestos.

Utilities Service Provider Notification

29. The demolition / construction plans shall be submitted to the appropriate water utility's office (e.g. Sydney Water office) to determine whether or not the development will affect the utility's sewer and water mains, stormwater drains and any easements.

Note: If the development complies with water utility's requirements, the plans will be stamped indicating that no further requirements are necessary.

Council Notification

30. The City of Canterbury Bankstown Council shall be advised by the building contractor in writing, of the date it is intended to commence work, including demolition. A minimum period of five (5) working days notification shall be given.

Site Safety

- 31. A sign shall be erected in a prominent position on the site:
 - (a) showing the name, address and telephone number of the responsible Land & Housing Corporation officer for the work, and
 - (b) showing the name of the principal contractor (if any) and the telephone number on which that person may be contacted during and outside working hours, and
 - (c) stating that unauthorised entry to the site is prohibited.

The sign shall be maintained while the work is being carried out but shall be removed when the work has been completed.

Note: This requirement does not apply in relation to building work that is carried out inside an existing building that does not affect the external walls of the building.

32. A minimum 1.8m high security fence or Class A / Class B (overhead) hoarding must be erected between the work site and any public place prior to demolition / construction. Access to the site shall be restricted to authorised persons only and the site shall be secured against unauthorised entry when demolition / construction work is not in progress or the site is otherwise unoccupied.

Note: Approval from the relevant roads authority may be required under Section 138 of the Roads Act 1993 where a Class A or B hoarding encroaches onto the footpath of / or a public thoroughfare within a classified road.

33. No building or demolition materials are to be stored on the footpath or roadway

Site Facilities

- 34. The following facilities shall be installed on the site:
 - (a) Toilet facilities shall be provided at the rate of 1 toilet for every 20 persons, or part thereof, employed at the site. Each toilet shall be a standard flushing toilet and shall be connected to a public sewer. If connection to a public sewer is not practicable, to an accredited sewerage management facility provided by The City of Canterbury Bankstown Council or if this is also not practicable to some other council approved management facility.
 - (b) Adequate refuse disposal methods and builders storage facilities. Builders' wastes, materials or sheds shall not be placed on any property other than that to which this activity relates.
- 35. Access to the site shall only be provided via an all weather driveway on the property and shall not be provided from any other site.

Protection of Trees

36. Trees and other vegetation that are to be retained on site shall be protected prior to the commencement of works and for the duration of the construction period in accordance with the details provided in the Arboricultural Impact Assessment Report.

Waste Management

37. A final Waste Management Plan shall be prepared and submitted to the Land & Housing Corporation by the building contractor prior to the commencement of demolition / construction. The plan shall detail the amount of waste material and the destination of all materials, recyclable and non-recyclable.

PRIOR TO ANY CONSTRUCTION WORK COMMENCING ON SITE

The following Identified Requirements are to be complied with prior to any construction works occurring on the site, excluding demolition.

Service Authority Clearances

38. A compliance certificate, or other evidence, shall be obtained from the relevant water utility provider (e.g. Sydney Water), confirming service availability prior to work commencing.

Note: Payment of water and/or sewer service charges and/or a notice of requirements for works to be carried out during construction / prior to occupation may be applicable prior to issue of the compliance certificate.

- 39. A written clearance from an electricity supply authority stating that electrical services are available to the site, or that arrangements have been entered into for the provision of services to the site, shall be obtained prior to work commencing.
- 40. A certificate from an approved telecommunications carrier certifying that satisfactory arrangements have been made for the provision of underground telephone services, to the site and to each dwelling, shall be obtained prior to work commencing.
- 41. Where the site is to be connected to reticulated gas, a certificate from an approved gas carrier certifying that satisfactory arrangements have been made for the provision of underground gas services, to the site and to each dwelling, shall be obtained prior to work commencing.

Stormwater Disposal

- 42. A detailed stormwater drainage plan(s), substantially in accordance with the approved concept stormwater drainage plan(s), shall be prepared and submitted to the Land & Housing Corporation. Any on-site detention system shall be designed in accordance with the relevant catchment authority's requirements (e.g. the Upper Parramatta River Catchment Trust On-site Detention Handbook) and/or the City of Canterbury Bankstown Council's drainage code.
- 43. Where a drainage easement is required, proof of lodgement of the plan of the drainage easement at the NSW Land Registry Services shall be submitted to the Land & Housing Corporation prior to commencement of works. Registration of the plan of easement shall be completed prior to occupation of the development and a copy of the registered plan shall be provided to the Land & Housing Corporation.

DURING DEMOLITION / CONSTRUCTION

The following Identified Requirements are to be complied with whilst works are occurring on the site.

Landfill

- 44. Where site filling is required, a minimum of 95% standard compacting shall be achieved and certified by a NATA registered Soils Laboratory.
- 45. Land fill materials must satisfy the following requirements:

- i. Shall be Virgin Excavated Natural Matter (VENM);
- ii. Shall be free of slag and hazardous, contaminated, putrescible, toxic or radioactive matter; and
- iii. Shall be free of industrial waste and building debris.

Heritage

- 46. Historic and indigenous archaeological sites and relics are protected under the *Heritage Act* 1977 and *National Parks and Wildlife Act* 1974, respectively. Should any relics be uncovered during the course of the approved works, work must cease immediately in the affected area. Subsequently, in cases where historical items have been uncovered, the Department of Planning and Environment must be contacted, or if Indigenous items have been uncovered, the Department of Planning and Environment, shall be contacted.
- 47. All workers / contractors on the site shall be informed of their obligations, under the Heritage Act and *National Parks and Wildlife Act 1974,* that it is illegal to disturb, damage or destroy a relic without the prior approval of the Department of Planning and Environment.

Demolition

- 48. Any existing structures identified for demolition shall be demolished prior to commencement of the construction of the activity.
- 49. Demolition shall be carried out in accordance with the appropriate provisions of AS 2601.
- 50. Where materials containing asbestos are to be removed, demolition shall be carried out by a licensed contractor(s) that has a current SafeWork NSW accreditation in asbestos removal.
- 51. Removal of asbestos-based thermal, or acoustic insulation such as sprayed asbestos and asbestos-based lagging and including friable asbestos boards, shall be carried out in accordance with the National Occupational Health and Safety Commission's Code of Practice for the Safe Removal of Asbestos, 2nd Edition [NOHSC:2002 (2005)].
- 52. Hazardous and intractable waste, including all asbestos laden waste arising from the demolition process shall be removed and disposed of in accordance with the requirements of SafeWork NSW.
- 53. Documentary evidence, in the form of tip receipts from an approved Waste Management Facility, shall be obtained by the demolition contractor and submitted to the Land & Housing Corporation demonstrating the appropriate disposal of the asbestos waste.
- 54. Demolition procedures shall maximise the reuse and recycling of demolished materials in order to reduce the environmental impacts of waste disposal.
- 55. During demolition, the public footpath and the public road shall not be obstructed by any vehicles. The public road and footpath shall be swept (not hosed) clean of any material, including clay, soil and sand.
- 56. All vehicles leaving the site with demolition materials shall have their loads covered and vehicles shall not track soil and other material onto the public roads and

footpaths. The footpath shall be suitably protected against damage when plant and vehicles access the site. All loading of vehicles with demolished materials shall occur on site.

Survey Reports

57. Survey reports shall be submitted by the building contractor to the Land & Housing Corporation prior to the placement of the footings / slab and on completion of the dwellings to verify the correct position of the structures in relation to the allotment boundaries.

Hours of Demolition / Construction / Civil Work

58. Demolition / construction / civil work shall only occur on the site between the hours of 7.00am to 5.00pm, Monday to Saturday with no work permitted on Sundays or public holidays.

Excavation & Backfilling

59. All excavations and backfilling associated with the demolition or erection of building(s) shall be executed safely and in accordance with appropriate professional standards. All such work shall be guarded and protected to prevent it from being dangerous to life or property.

Pollution Control

- 60. Any noise generated during the carrying out of the activity shall not exceed the limits specified in the July 2009 Interim Construction Noise Guidelines published by the former Department of Environment and Climate Change.
- 61. No fires shall be lit, or waste materials burnt, on the site.
- 62. No washing of concrete forms or trucks shall occur on the site.
- 63. Any contamination / spills on the site during construction works shall be actively managed and reported immediately to the appropriate regulatory authorities to minimise any potential damage to the environment.
- 64. Dust generation during demolition / construction shall be controlled using regular control measures such as on site watering or damp cloth fences.
- 65. All vehicles transporting loose materials and travelling on public roads shall be secured (i.e. closed tail gate and covered) to minimise dust generation.
- 66. Non-recyclable waste and containers shall be regularly collected and disposed of at a licensed landfill or other disposal site in accordance with details set out in the final Waste Management Plan.

Impact of Construction Works

67. The Land & Housing Corporation shall bear the cost of any necessary adjustments to utility mains and services.

68. Care shall be taken to prevent any damage to adjoining properties. The building contractor shall be liable to pay compensation to any adjoining owner if, due to demolition/construction works, damage is caused to such adjoining property.

Termite Protection

69. To protect buildings from subterranean termite, termite barriers installed in accordance with AS 3660.1, shall be placed on the underside and in penetrations of the concrete slab floor.

In addition, a durable notice must be permanently fixed inside the meter box indicating:

- (a) the method of protection;
- (b) the date of installation of the system;
- (c) where a chemical barrier is used, its life expectancy as listed on the National Registration Authority label; and
- (d) the need to maintain and inspect the system on a regular basis.

PRIOR TO OCCUPATION OF THE DEVELOPMENT

The following Identified Requirements are to be complied with prior to the occupation of the development.

General

70. The occupation of the development shall not commence until all the Identified Requirements of this Determination have been complied with.

Council Infrastructure Damage

71. The cost of repairing any damage caused to the City of Canterbury Bankstown Council's assets in the vicinity of the site as a result of demolition / construction works shall be met in full by the building contractor.

Stormwater Drainage

- 72. Prior to occupation, a Work As Executed Plan shall be prepared by the building contractor clearly showing all aspects of the constructed stormwater drainage system, including any on-site detention system. The plan shall demonstrate general compliance with the approved concept stormwater drainage plan(s) and shall include:
 - sufficient levels and dimensions to verify the constructed storage volumes; and
 - location and surface levels of all pits; and
 - invert levels of the internal drainage lines, orifice plates fitted and levels within the outlet control pits; and
 - finished floor levels of all structures; and
 - verification that any required trash screens have been installed; and
 - locations and levels of any overland flow paths; and
 - verification that any drainage lines are located wholly within easements, where applicable.

The Work-As-Executed Plan information shall be shown on the final civil works drawings.

A positive covenant and restriction-as-to-user shall be placed over the onsite detention system in accordance with the City of Canterbury Bankstown Council's onsite detention policy to ensure that the system will be adequately maintained. The positive covenant and restriction-as-to-user shall be registered at NSW Land Registry Services prior to occupation. A copy of the registered restriction-as-to-user shall be provided to the Land & Housing Corporation and the City of Canterbury Bankstown Council.

PART B - Additional Identified Requirements

Specific Requirements for Seniors Housing

73. The independent living units shall comply with the accessibility and useability standards referenced in section 85 and set out in Schedule 4 of State Environmental Planning Policy (Housing) 2021.

Note: This requirement does not apply to the provisions set out under sections 2, 7-13 and 15-20 of Schedule 4 for an independent living unit, or part of such a unit, that is located above the ground floor.

- 74. Only the following kinds of people shall be accommodated in the approved development:
 - (a) seniors or people who have a disability; or
 - (b) people who live within the same household with seniors or people who have a disability; or
 - (c) staff employed to assist in the administration and provision of services to the seniors housing development.

Note: It should be noted that 'seniors', as defined in the Housing SEPP, are any of the following:

- (a) people aged 60 or more years,
- (b) people who are resident at a facility at which residential care (within the meaning of the Aged Care Act 1997 of the Commonwealth) is provided, and
- (c) people who have been assessed as being eligible to occupy housing for aged persons provided by a social housing provider.

A restriction as to user shall be registered against the title of the property, prior to occupation, in accordance with Section 88E of the Conveyancing Act 1919 limiting the use of any accommodation to the kinds of people referred to above and that the dwellings cannot be subdivided.

- 75. Pathway lighting shall be designed to provide a minimum of 20 lux at ground level and be located to avoid glare for pedestrians and adjacent dwellings.
- 76. Access to, and within, the site shall be provided in accordance with AS 1428.1 so that a person using a wheelchair can use common areas and common facilities associated with the activity.
- 77. The footpath at bus stop (ID. 2163113) on the eastern side of Lowana Street shall be extended in accordance with the City of Canterbury Bankstown Council's specifications to provide an accessible path of travel from the pram ramp at the corner of Lowana Street and Alcoomie Street to the bus stop.

Note: The responsible officer at the City of Canterbury Bankstown Council shall be contacted regarding council's specifications and any necessary approvals.

78. Entry doors to units shall to be provided with door viewers to enable residents to view approaches to their units without the need to open the door.

Site Specific Requirements

- 79. Construction works are to be carried out in accordance with the tree-sensitive construction methodologies and procedures specified in Sections 3.2 to 3.10 of the Arboricultural Impact Assessment Report (Arterra Design, 14 February 2023).
- 80. The palisade fencing around the rear private open space of the ground floor units must be spaced and angled to provide privacy for users of the private open space.
- 81. A Site Clearance Certificate is to be issued by a suitably qualified person for all three lots once all existing dwellings on the site are demolished to confirm the site is free of asbestos.

Requirements Resulting from Council Comments

82. The following replacement trees are to be planted forward of the property prior to occupation. The trees shall have a container size not less than 75 litres, shall comply with NATSPEC Specifying Trees: a guide to assessment of tree quality (2003) or Australian Standard AS 2303 – 2015. Tree stock for landscape use and be planted and maintained in accordance with Council's street tree planting Standard Drawing No. S-201.

Species	Location
6 x Tristaniopsis laurina (Water Gum), OR 6 x Buckinghamia celsissma (Ivory Curl), OR 6 x Cupaniopsis anacardioides (Tuckeroo)	To be planted on the nature strip forward of 18-22 Mundamatta Street, Villawood. Trees to be spaced evenly between the New Vehicle Footpath Crossings no closer than 2.5m to the New Vehicle
	Footpath Crossings.

ADVISORY NOTES

- i. Approval of this development activity does not imply or infer compliance with Section 23 of the Disability Discrimination Act 1992. Refer to AS 1428.1 and the Building Code of Australia for detailed guidance.
- ii. Information regarding the location of underground services may be obtained from Dial Before You Dig at *www.1100.com.au* or by dialing 1100.



Decision Statement

Project No. BGYHY

SITE IDENTIFICATION		
STREET ADDRESS		
Unit/Street No	Street or property name	
18-22	Mundamatta Street	
Suburb, town or locality		Postcode
Villawood, NSW		2163
Local Government Area(s)	Real property description (Lot and DP)	
Canterbury Bankstown	Lots 814, 815 & 816 in DP 36608	

ACTIVITY DESCRIPTION

Provide a description of the activity

Demolition of existing dwellings and structures, removal of trees, and the construction of a seniors housing development comprising of 12 independent living seniors housing units (7 x 1 bedroom and 5 x 2 bedroom units) with associated landscaping and fencing, surface parking for 6 cars, consolidation of 3 lots into a single lot and construction of a stormwater drainage pipeline and easement over Lot 807 DP 36608, No. 82 Lowana Street.

The Land & Housing Corporation (LAHC) has proposed the above activity under the provisions of *State Environmental Planning Policy (Housing) 2021* (Housing SEPP) which requires determination under Part 5 of the *Environmental Planning & Assessment Act 1979* (EP&A Act). This Decision Statement relates to the Review of Environmental Factors (REF) for the above activity prepared under Part 5 of the EP&A Act and the *Environmental Planning and Assessment Regulation 2021*.

Based on the REF document and supporting documentation, including advice from the City of Canterbury Bankstown Council, a decision to proceed with the proposed activity has been made. This decision included consideration of the following:

Significant Impact on the Environment

- The proposed activity is not likely to have a significant impact on the environment and therefore an EIS is not required.
- The proposed activity will not be carried out in a declared area of outstanding biodiversity value and is not likely to significantly affect threatened species, populations or ecological communities, or their habitats or impact biodiversity values, meaning a SIS and/or BDAR is not required.

Reasons for the Decision

 Following an assessment of the proposed activity and associated environmental impacts within the REF it was decided that the proposed group homes will have economic and social benefits and any minor short-term impacts on the environment or surrounding properties can be appropriately mitigated.

• The proposed development will assist in the provision of much needed social and affordable housing and assist in addressing the existing and growing demand for housing in the local government area.

Mitigation Measures

• Mitigation measures are required to minimise or manage environmental impacts and are detailed throughout the REF and specifically within Section 7. All mitigation measures are detailed as Identified Requirements within the Activity Determination. Additional mitigation measures, detailed in the Activity Determination have been imposed to minimise the impact on the surrounding environment, ensure appropriate site safety and to ensure legislative compliance.

bein Signed.....

Dated....24 August 2023

Emma Nicholson Acting Head of Policy and Innovation Land and Housing Corporation Department of Planning & Environment

[3406] 18-22 MUNDAMATTA STREET, VILLAWOOD NSW 2163 LOTS 814-816 DP 36608 [LOT 807 DP 36608 NO. 82 FOR SW EASEMENT ONLY] **BGYHY- SENIORS HOUSING DEVELOPMENT** LAND AND HOUSING CORPORATION






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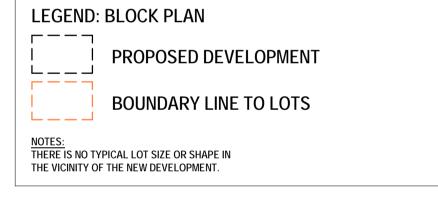
		Regulate	ed Design	Record	
Project	Address: 18-22	MUNDAMATTA STREET	r, villawoo	DD NSW 2163	
Project	Title: SENI	ORS HOUSING DEVELO	PMENT, LAN	ID AND HOUSING CORP	ORATION
Conser	nt No: COVER P	AGE	Body Co	rporate Reg No: DA-	0.00
Drawin	g Title:		Drawing	No:	
Rev	Date dd.mm.yy	Description		DP Full Name	Reg. No.
6	16.11.22	For Approval		Craig Shelsher	DEP0001741


Site Area	2210.36 m ²			
Number of dwellings	12 units (7 x 1 Bed + 5 x 2 Beds)			
	Control	Requirement	Proposed	
Front Setback	Canterbury Bankstown Council	5.5m	5.5m	
Side Setback	Canterbury Bankstown Council	3 m	3 m	
Rear Setback	Canterbury Bankstown Council	Set by Sewerline and easement	Set by Sewerline and easement	
Height	SEPP Housing 2021	9.5m building height (top of ridge)	7.2m building height (top of ridge)	
Floor Space Ratio	SEPP Housing 2021	0.5 : 1	0.36:1	
	Canterbury Bankstown Council	N/A	N/A	
Landscape	SEPP Housing 2021	35m2 per unit = 420m2.	950 m2	
Deep Soil Zone 15% of site with minimum dimensions of 3m	SEPP Housing 2021	331.5 m2	583 m2	
65% of this at rear	SEPP Housing 2021	378.95 m2	488 m2	
70% of dwellings to have three hours sunlight to living areas and to associated private open space	SEPP Housing 2021	9	10 83% of development	
Parking	SEPP Housing 2021	0.4 spaces / 1 bed (7) = 2.8 0.5 spaces / 2bed (5) = 2.5 TOTAL SPACES = 6	6 spaces: 2 Accessible spaces with common shared area 1 separate dedicated Accessible space 3 standard spaces	



SHEET NAME

COVER PAGE SITE ANALYSIS

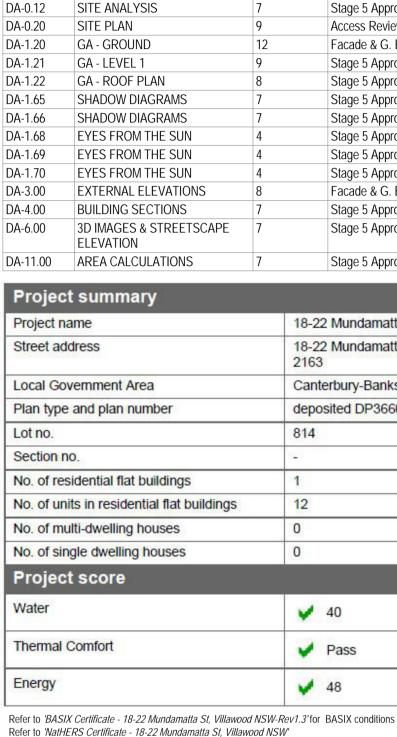

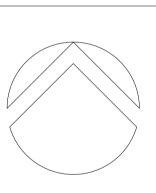

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Revision	Description	Date
1	For Coordination	12/07/22
2	Progress Issue	28/07/22
3	Stage B Submission	05/08/22
4	For Approval	16/09/22
5	DA Issue	26/10/22
6	Part 5 Application	16/11/22
7	Stage 5 Approval- Addendum	17/11/22
8	Facade & G. Enclosure Update	14/02/23

CURRENT REVISION	CURRENT REVISION DESCRIPTION	CURRENT REVISION DATE
8	Facade & G. Enclosure Update	14/02/23
8	Stage 5 Approval- Addendum	17/11/22
7	Stage 5 Approval- Addendum	17/11/22
9	Access Review	22/11/22
12	Facade & G. Enclosure Update	14/02/23
9	Stage 5 Approval- Addendum	17/11/22
8	Stage 5 Approval- Addendum	17/11/22
7	Stage 5 Approval- Addendum	17/11/22
7	Stage 5 Approval- Addendum	17/11/22
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7	Stage 5 Approval- Addendum	17/11/22
7	Stage 5 Approval- Addendum	17/11/22

DA DRAWING LIST

18-22 Mundamatta	St, Villawood NSW 2163
18-22 Mundamatta 9 2163	Street Villawood NSW
Canterbury-Banksto	wn Council
deposited DP36608	
814	
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48	Target 45
	18-22 Mundamatta s 2163 Canterbury-Banksto deposited DP36608 814 - 1 12 0 0 0 2163 20100 0 20100 </td



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3. EXISTING STRUCTURES AND SERVICES Extent and location of existing and proposed neighbouring structures and services is according to the available survey information and will need to be verified on site at later stage

THIS DRAWING IS TO BE **PRINTED IN COLOUR**

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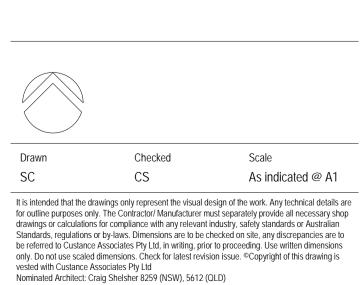
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Project 18-22 MUNDAMATTA STREET, VILLAWOOD NSW 2163 LOTS 814-816 SENIORS HOUSING DEVELOPMENT


Sheet Title

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		Regulated	d Design	Record	
Project	Address: 18-22	MUNDAMATTA STREET,	, VILLAWOC	DD NSW 2163	
Project	Title: SENIO	ORS HOUSING DEVELOP	MENT, LAN	D AND HOUSING CORP	ORATION
Conser	nt No:		Body Co	rporate Reg No:	
Drawing Title: SITE ANALYSIS 1			Drawing	Drawing No: DA-0.11	
Rev	Date dd.mm.yy	Description		DP Full Name	Reg. No.
7	16.11.22	For Approval		Craig Shelsher	DEP0001741



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Revision Description

ICC VISION	Description	Date
1	For Coordination	12/07/22
2	Progress Issue	28/07/22
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4	For Coordination	26/08/22
5	For Approval	16/09/22
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7	Part 5 Application	16/11/22
8	Stage 5 Approval- Addendum	17/11/22
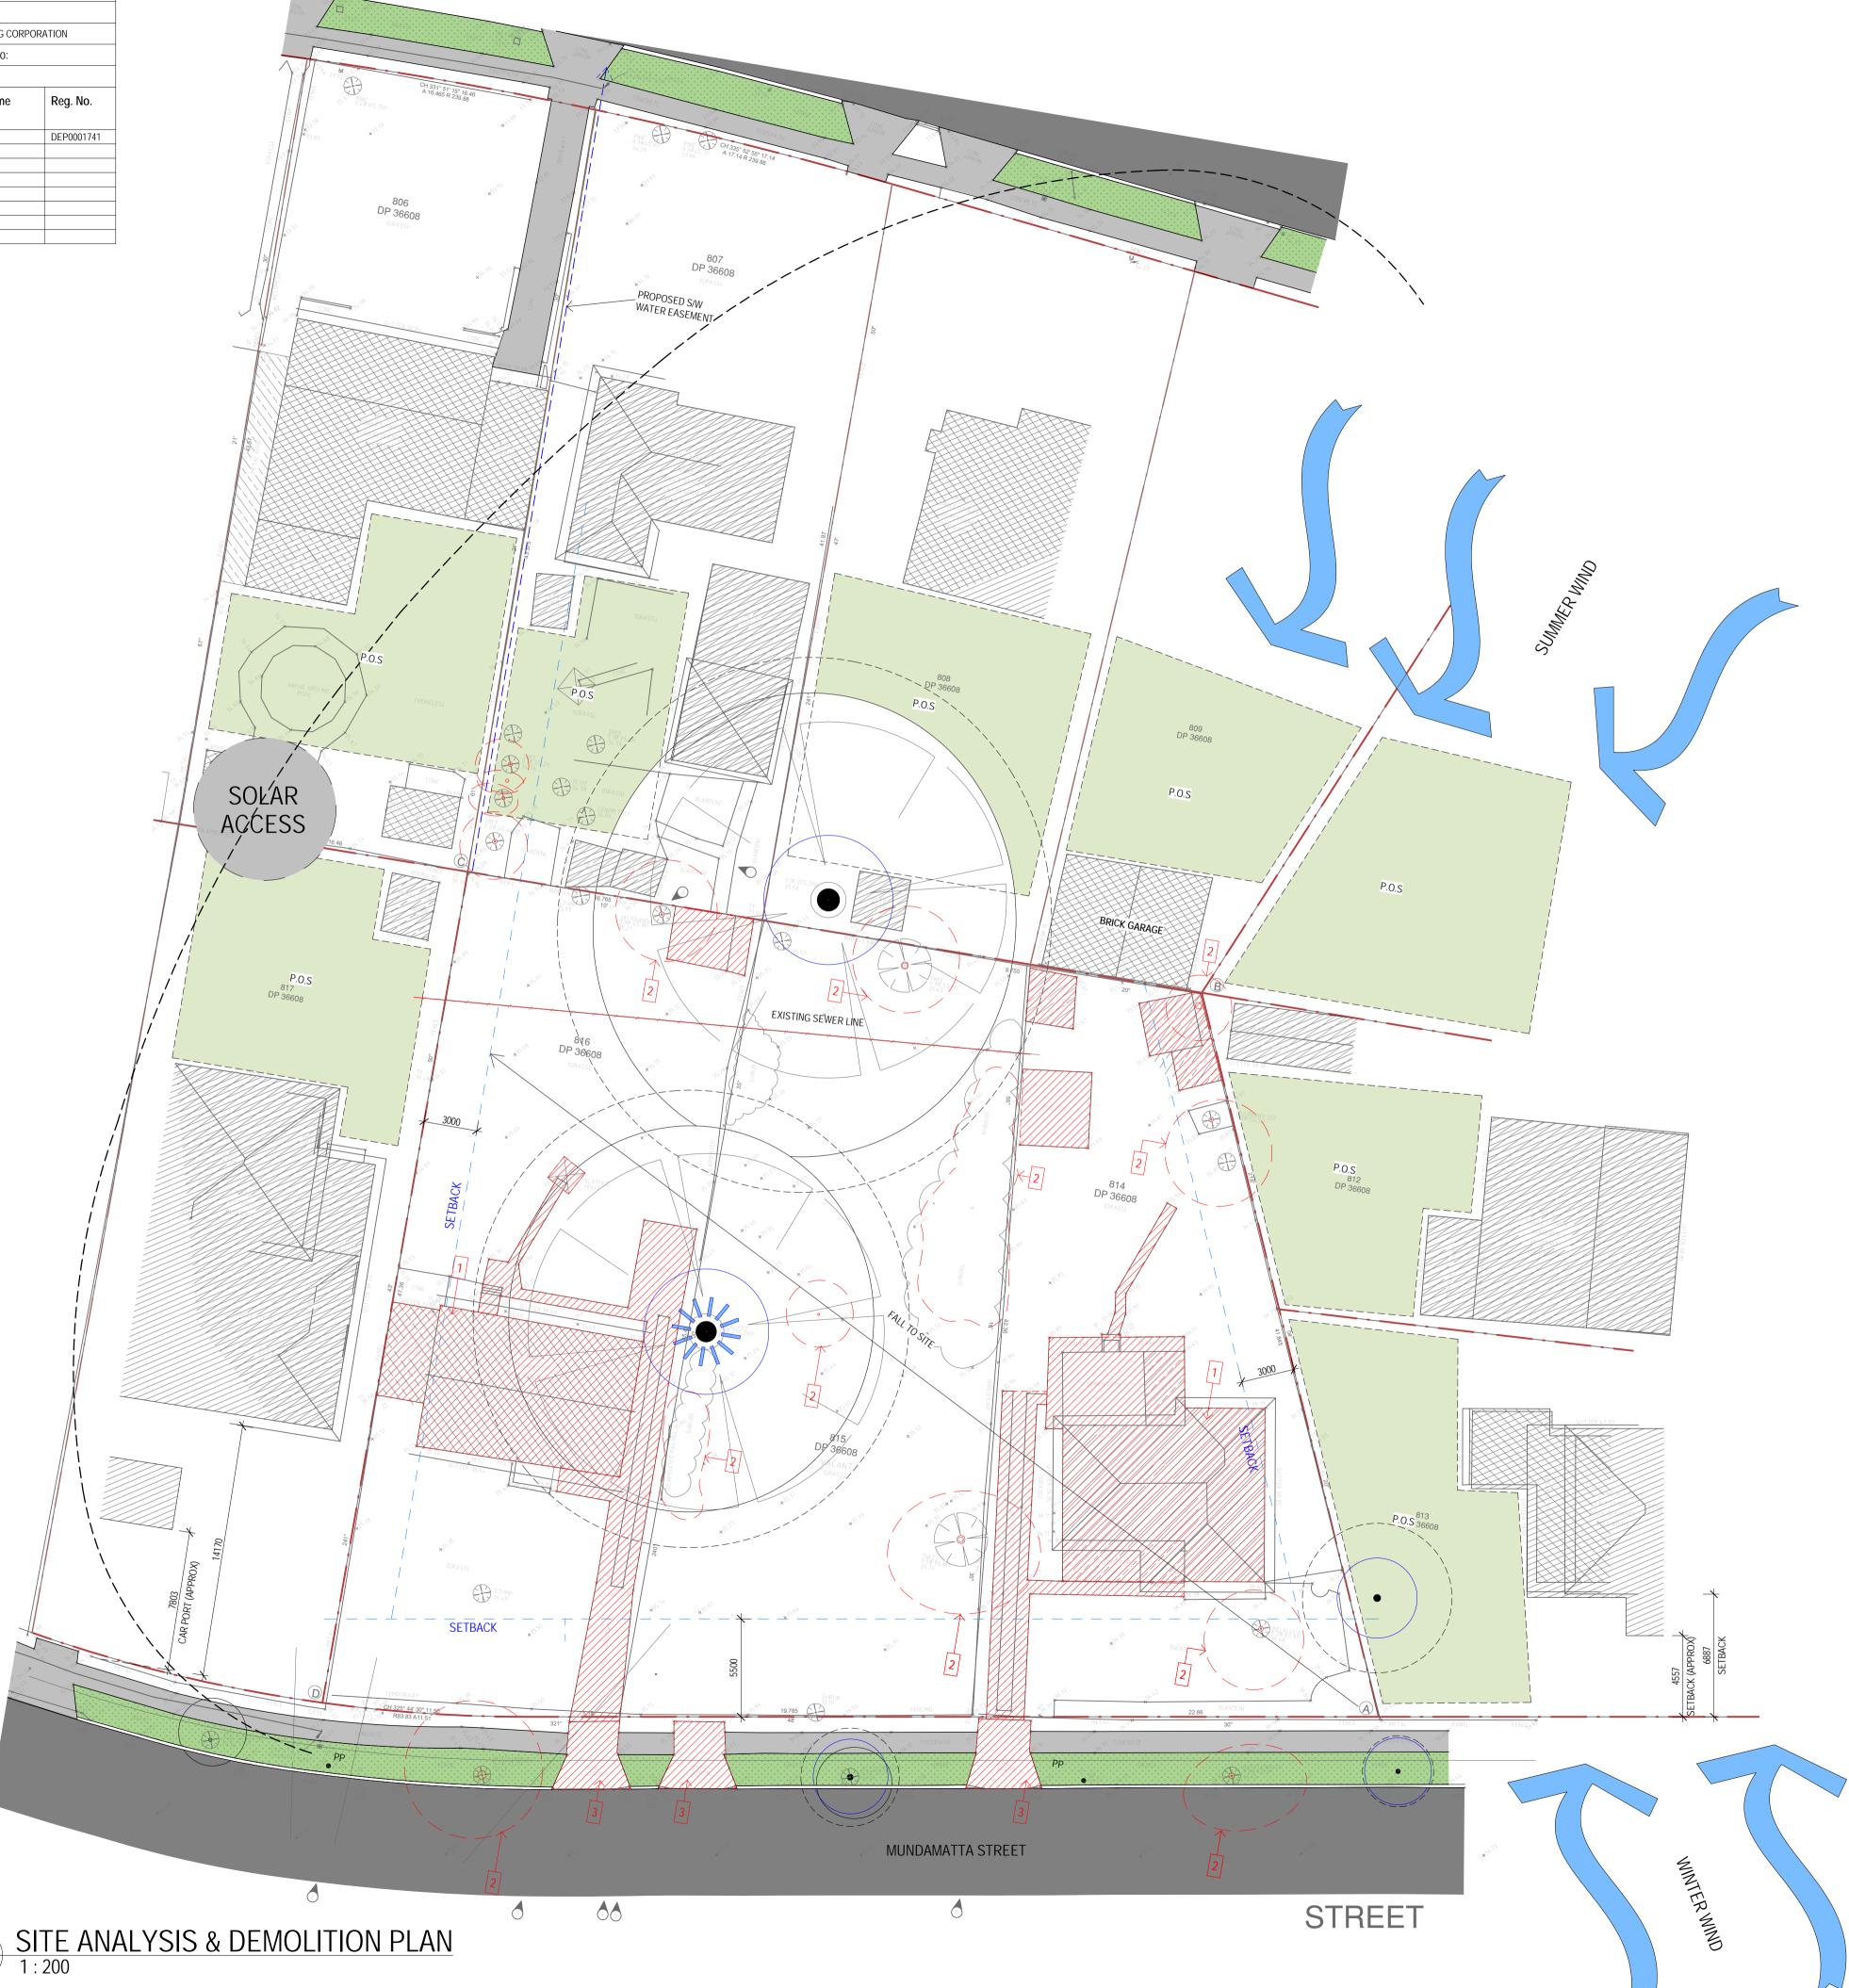
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Project 18-22 MUNDAMATTA STREET, VILLAWOOD NSW 2163 LOTS 814-816 SENIORS HOUSING DEVELOPMENT


Sheet Title

SITE ANALYSIS



Project No. 3406


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Sheet No. Revision 8

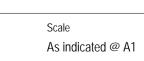CS



REFER TO ARBORIST REPORT AND

INSTALL TREE PROTECTION TO AS 4970
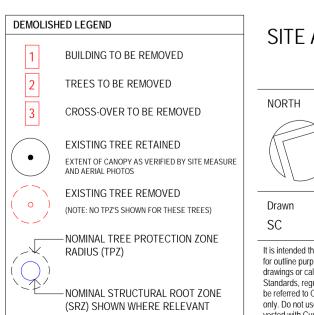
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		Dogulato	d Design R	Decord	
Project	Address: 18-22	MUNDAMATTA STREET	•		
Project	Title: SENIO	ORS HOUSING DEVELOP	MENT, LAND	AND HOUSING CORP	ORATION
Conser	nt No:		Body Corp	oorate Reg No:	
Drawin	g Title: SITE	ANALYSIS 2	Drawing No: DA-0.12		
Rev	Date dd.mm.yy	Description		DP Full Name	Reg. No.
6	16.11.22	For Approval	(Craig Shelsher	DEP0001741



ACCESS TO TRANSPORT



SITE LOCATION



1 - VIEW TO THE SITE - MUNDAMATTA STREET









3 - STREET VIEW TO THE SITE (FROM LOT 16 - 24) - MUNDAMATTA STREET

5 - STREET VIEW TO THE SITE (FROM LOT 24 - 16) - MUNDAMATTA STREET



NEIGHBOURS PRIVATE OPEN SPACE



2 - VIEW FROM THE SITE - FRONT NEIGHBOURS - MUNDAMATTA STREET



4 - STREET VIEW TO THE SITE (FROM LOT 21 - 27) - MUNDAMATTA STREET



6 - STREET VIEW TO THE SITE (FROM LOT 27 - 21) - MUNDAMATTA STREET



12/07/22
28/07/22
05/08/22
16/09/22
26/10/22
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17/11/22

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Project 18-22 MUNDAMATTA STREET, VILLAWOOD NSW 2163 LOTS 814-816 SENIORS HOUSING DEVELOPMENT

Sheet Title


SITE ANALYSIS

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It is intended that the for outline purposes o drawings or calculatio Standards, regulation be referred to Custanc only. Do not use scale vested with Custance	drawings only represent the visual of inly. The Contractor/ Manufacturer n ins for compliance with any relevant s or by-laws. Dimensions are to be ce Associates Pty Ltd, in writing, privi ed dimensions. Check for latest revi	design of the work. Any technical details are nust separately provide all necessary shop industry, safety standards or Australian checked on site, any discrepancies are to or to proceeding. Use written dimensions sion issue. ©Copyright of this drawing is

Project No. 3406 Sheet No.RevisionDA-0.127





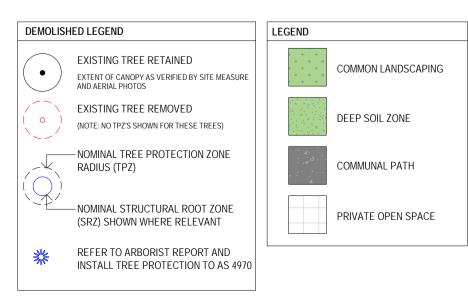

Revision	Description	Date
1	For Coordination	12/07/22
2	Progress Issue	28/07/22
3	Stage B Submission	05/08/22
4	For Coordination	26/08/22
5	For Approval	16/09/22
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9	Access Review	22/11/22

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Project

18-22 MUNDAMATTA STREET, VILLAWOOD NSW 2163 LOTS 814-816 SENIORS HOUSING DEVELOPMENT

Sheet Title

SITE PLAN



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Sheet No.

- *POS OF GROUND FLOOR ARE BIGGER TO COMPLY WITH SEPP (MIN 15 SQ.MTS) - ALL BALCONY AREAS TO COMPLY WITH SEPP AND LAHC STANDARDS

- ALL UNITS COMPLY WITH AS1428.1 CLEARANCES INTERNALLY - ALL UNITS HAVE ALLOCATED SPACE FOR PROVISION OF GRABRAILS IN BATHROOMS

NOTE: REFER TO LANDSCAPE PLAN FOR PLANT SCREENING IN WESTFACING FRONT GARDENS ALL AREA CALCS AND RL'S ARE INDICATIVE SUBJECT TO FUTURE DESIGN DEVELOPMENT







24 August 2023

Ξ	P.0	P.O.S AREA	
AREA	TYPE	AREA	AREA TOTAL
m²	P.O.S	24.99 m ²	85.49 m ²
m²	P.O.S	24.57 m ²	84.08 m ²
m²	P.O.S	20.04 m ²	79.98 m ²
m²	P.O.S	43.08 m ²	113.67 m ²
m²	P.O.S	42.73 m ²	113.56 m ²
m²	P.O.S	76.18 m ²	147.36 m ²
m²	P.O.S	15.02 m ²	90.38 m ²
m²	BALCONY	11.26 m ²	72.38 m ²
m²	BALCONY	11.85 m ²	71.35 m ²
m²	BALCONY	11.14 m ²	71.07 m ²
m ²	BALCONY	10.54 m ²	80.74 m ²
m²	BALCONY	11.09 m ²	70.28 m ²
7 m²		302.49 m ²	1080.36 m ²

UNIT TYPE - 1 BED

UNIT TYPE - 2 BED

PRIVATE OPEN SPACE / BALCONY

TPZ ENCROACHMENT ZONE

DENOTES TREE TRUNK. REFER TO ARBORIST REPORT FOR DETAILS

TREE CANOPY. REFER TO ARBORIST REPORT FOR DETAILS

STRUCTURAL ROOT ZONE. REFER TO ARBORIST REPORT FOR DETAILS

TREE PROTECTION ZONE.. REFER TO ARBORIST REPORT FOR DETAILS

TREE TO BE REMOVED. REFER TO ARBORIST REPORT FOR DETAILS

RL. 35.62

EXISTING RL. REFER TO SURVEY PLAN FOR DETAILS

RL 35.80 PROPOSED RL.

WATERGUM TREES PROPOSED (EXACT LOCATION TBC)

Description

Description	Dale
Progress Issue	28/07/22
Stage B Submission	05/08/22
For Coordination	26/08/22
For Access Review	09/09/22
For Approval	16/09/22
DA Issue	26/10/22
Client Review	07/11/22
Part 5 Application	16/11/22
Stage 5 Approval- Addendum	17/11/22
Access Review	22/11/22
Facade & G. Enclosure Update	14/02/23
	Progress Issue Stage B Submission For Coordination For Access Review For Approval DA Issue Client Review Part 5 Application Stage 5 Approval- Addendum Access Review

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Client



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Project 18-22 MUNDAMATTA STREET, VILLAWOOD NSW 2163 LOTS 814-816 SENIORS HOUSING DEVELOPMENT

Sheet Title

GA - GROUND



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Checked

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Project No. 3406

2 **C**A-3.00 \mathbb{R} 0





DA-3.00

Electric 24 August 2023

	P.0	AREA TOTAL	
REA	TYPE	AREA	
2	P.O.S	24.99 m ²	85.49 m ²
2	P.O.S	24.57 m ²	84.08 m ²
2	P.O.S	20.04 m ²	79.98 m ²
2	P.O.S	43.08 m ²	113.67 m ²
2	P.O.S	42.73 m ²	113.56 m ²
2	P.O.S	76.18 m ²	147.36 m ²
2	P.O.S	15.02 m ²	90.38 m ²
2	BALCONY	11.26 m ²	72.38 m ²
2	BALCONY	11.85 m ²	71.35 m ²
2	BALCONY	11.14 m ²	71.07 m ²
2	BALCONY	10.54 m ²	80.74 m ²
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n²		302.49 m ²	1080.36 m ²

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TREE TO BE REMOVED. REFER TO ARBORIST REPORT FOR DETAILS

EXISTING RL. REFER TO SURVEY PLAN FOR DETAILS

WATERGUM TREES PROPOSED (EXACT LOCATION TBC)

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REVISION	Description	Dale
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Project 18-22 MUNDAMATTA STREET, VILLAWOOD NSW 2163 LOTS 814-816 SENIORS HOUSING DEVELOPMENT

Sheet Title

GA - LEVEL 1



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> Scale As indicated @ A1

> > Revision

9

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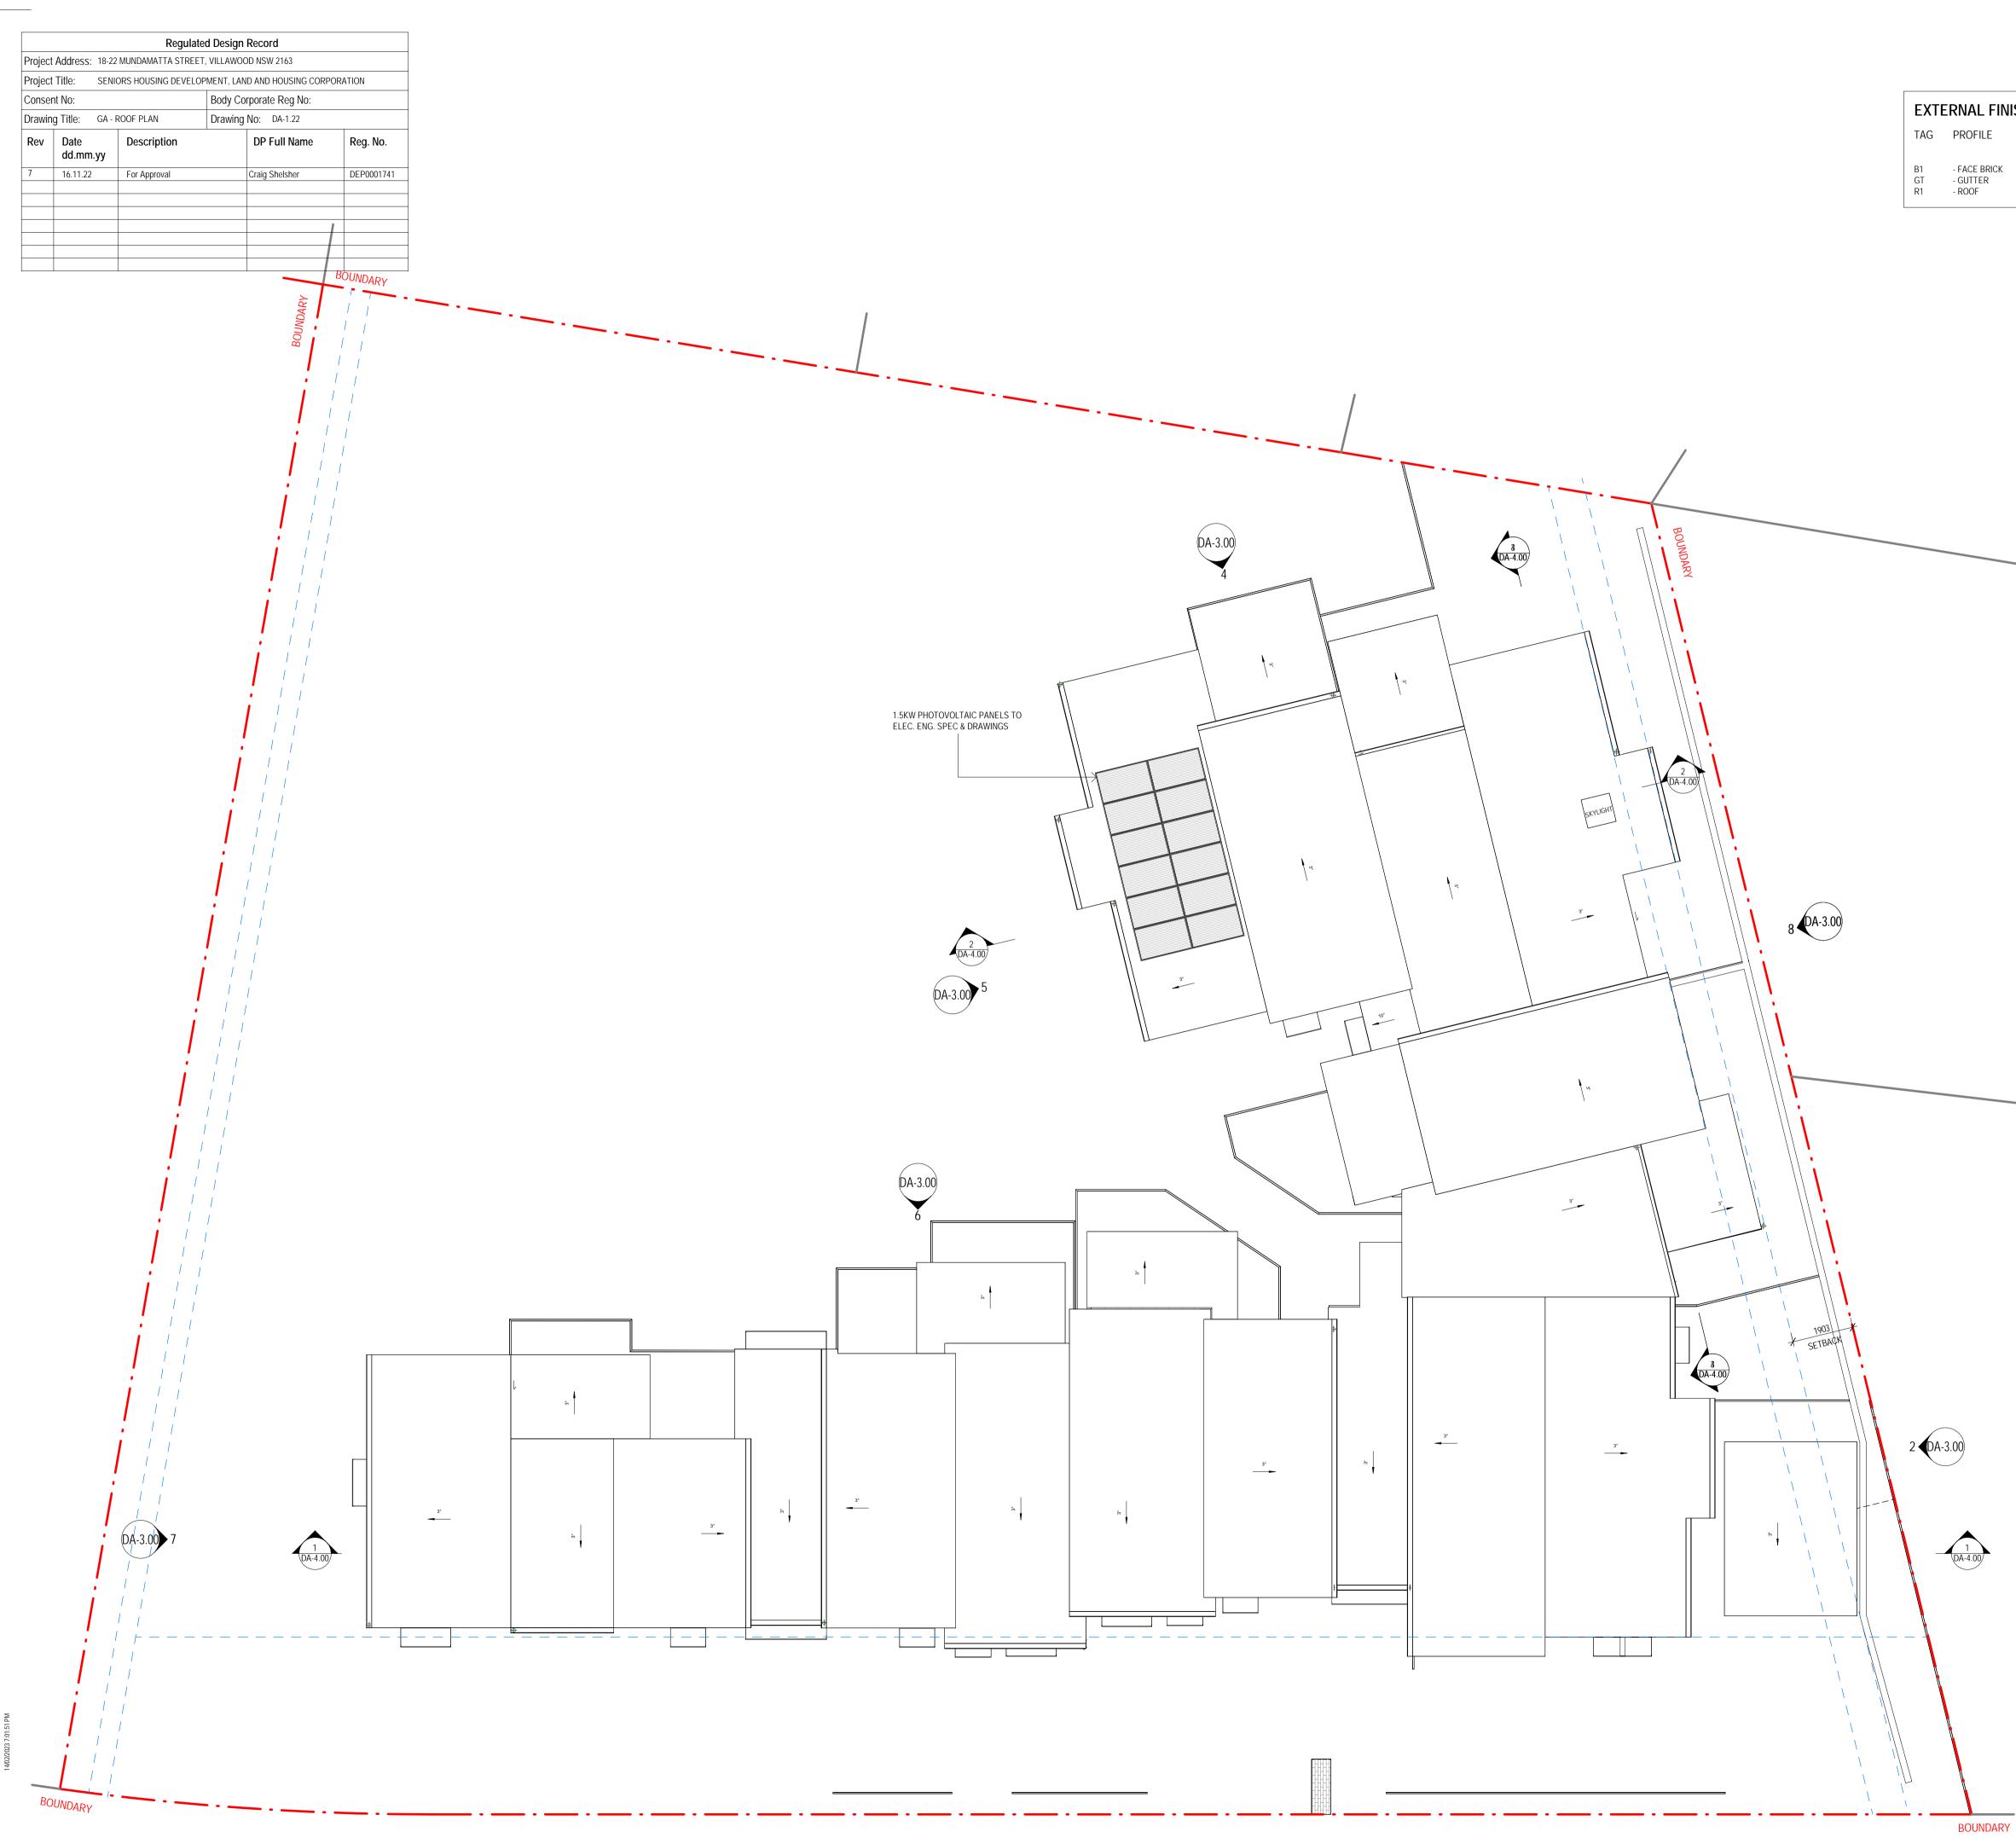
vested with Custance Associates Pty Ltd Nominated Architect: Craig Shelsher 8259 (NSW), 5612 (QLD)


Sheet No.

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CS







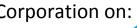

EXTERNAL FINISHES SCHEDULE

FINISH/ MANUFACTURER

- AUSTRAL - COLORBOND - COLORBOND COLOUR - BOWRAL BROWN - WOODLAND GREY - WOODLAND GREY

Revision	Description	Date
	For Coordination	12/07/22
2	Progress Issue	28/07/22
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3	Stage 5 Approval- Addendum	17/11/22

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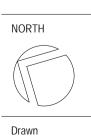
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Project 18-22 MUNDAMATTA STREET, VILLAWOOD NSW 2163 LOTS 814-816 SENIORS HOUSING DEVELOPMENT

Sheet Title

ga - Roof Plan



SC

SCALE @ A1 1:100 2.5 0 Checked

DA-1.22 8




Revision

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CS

Sheet No.



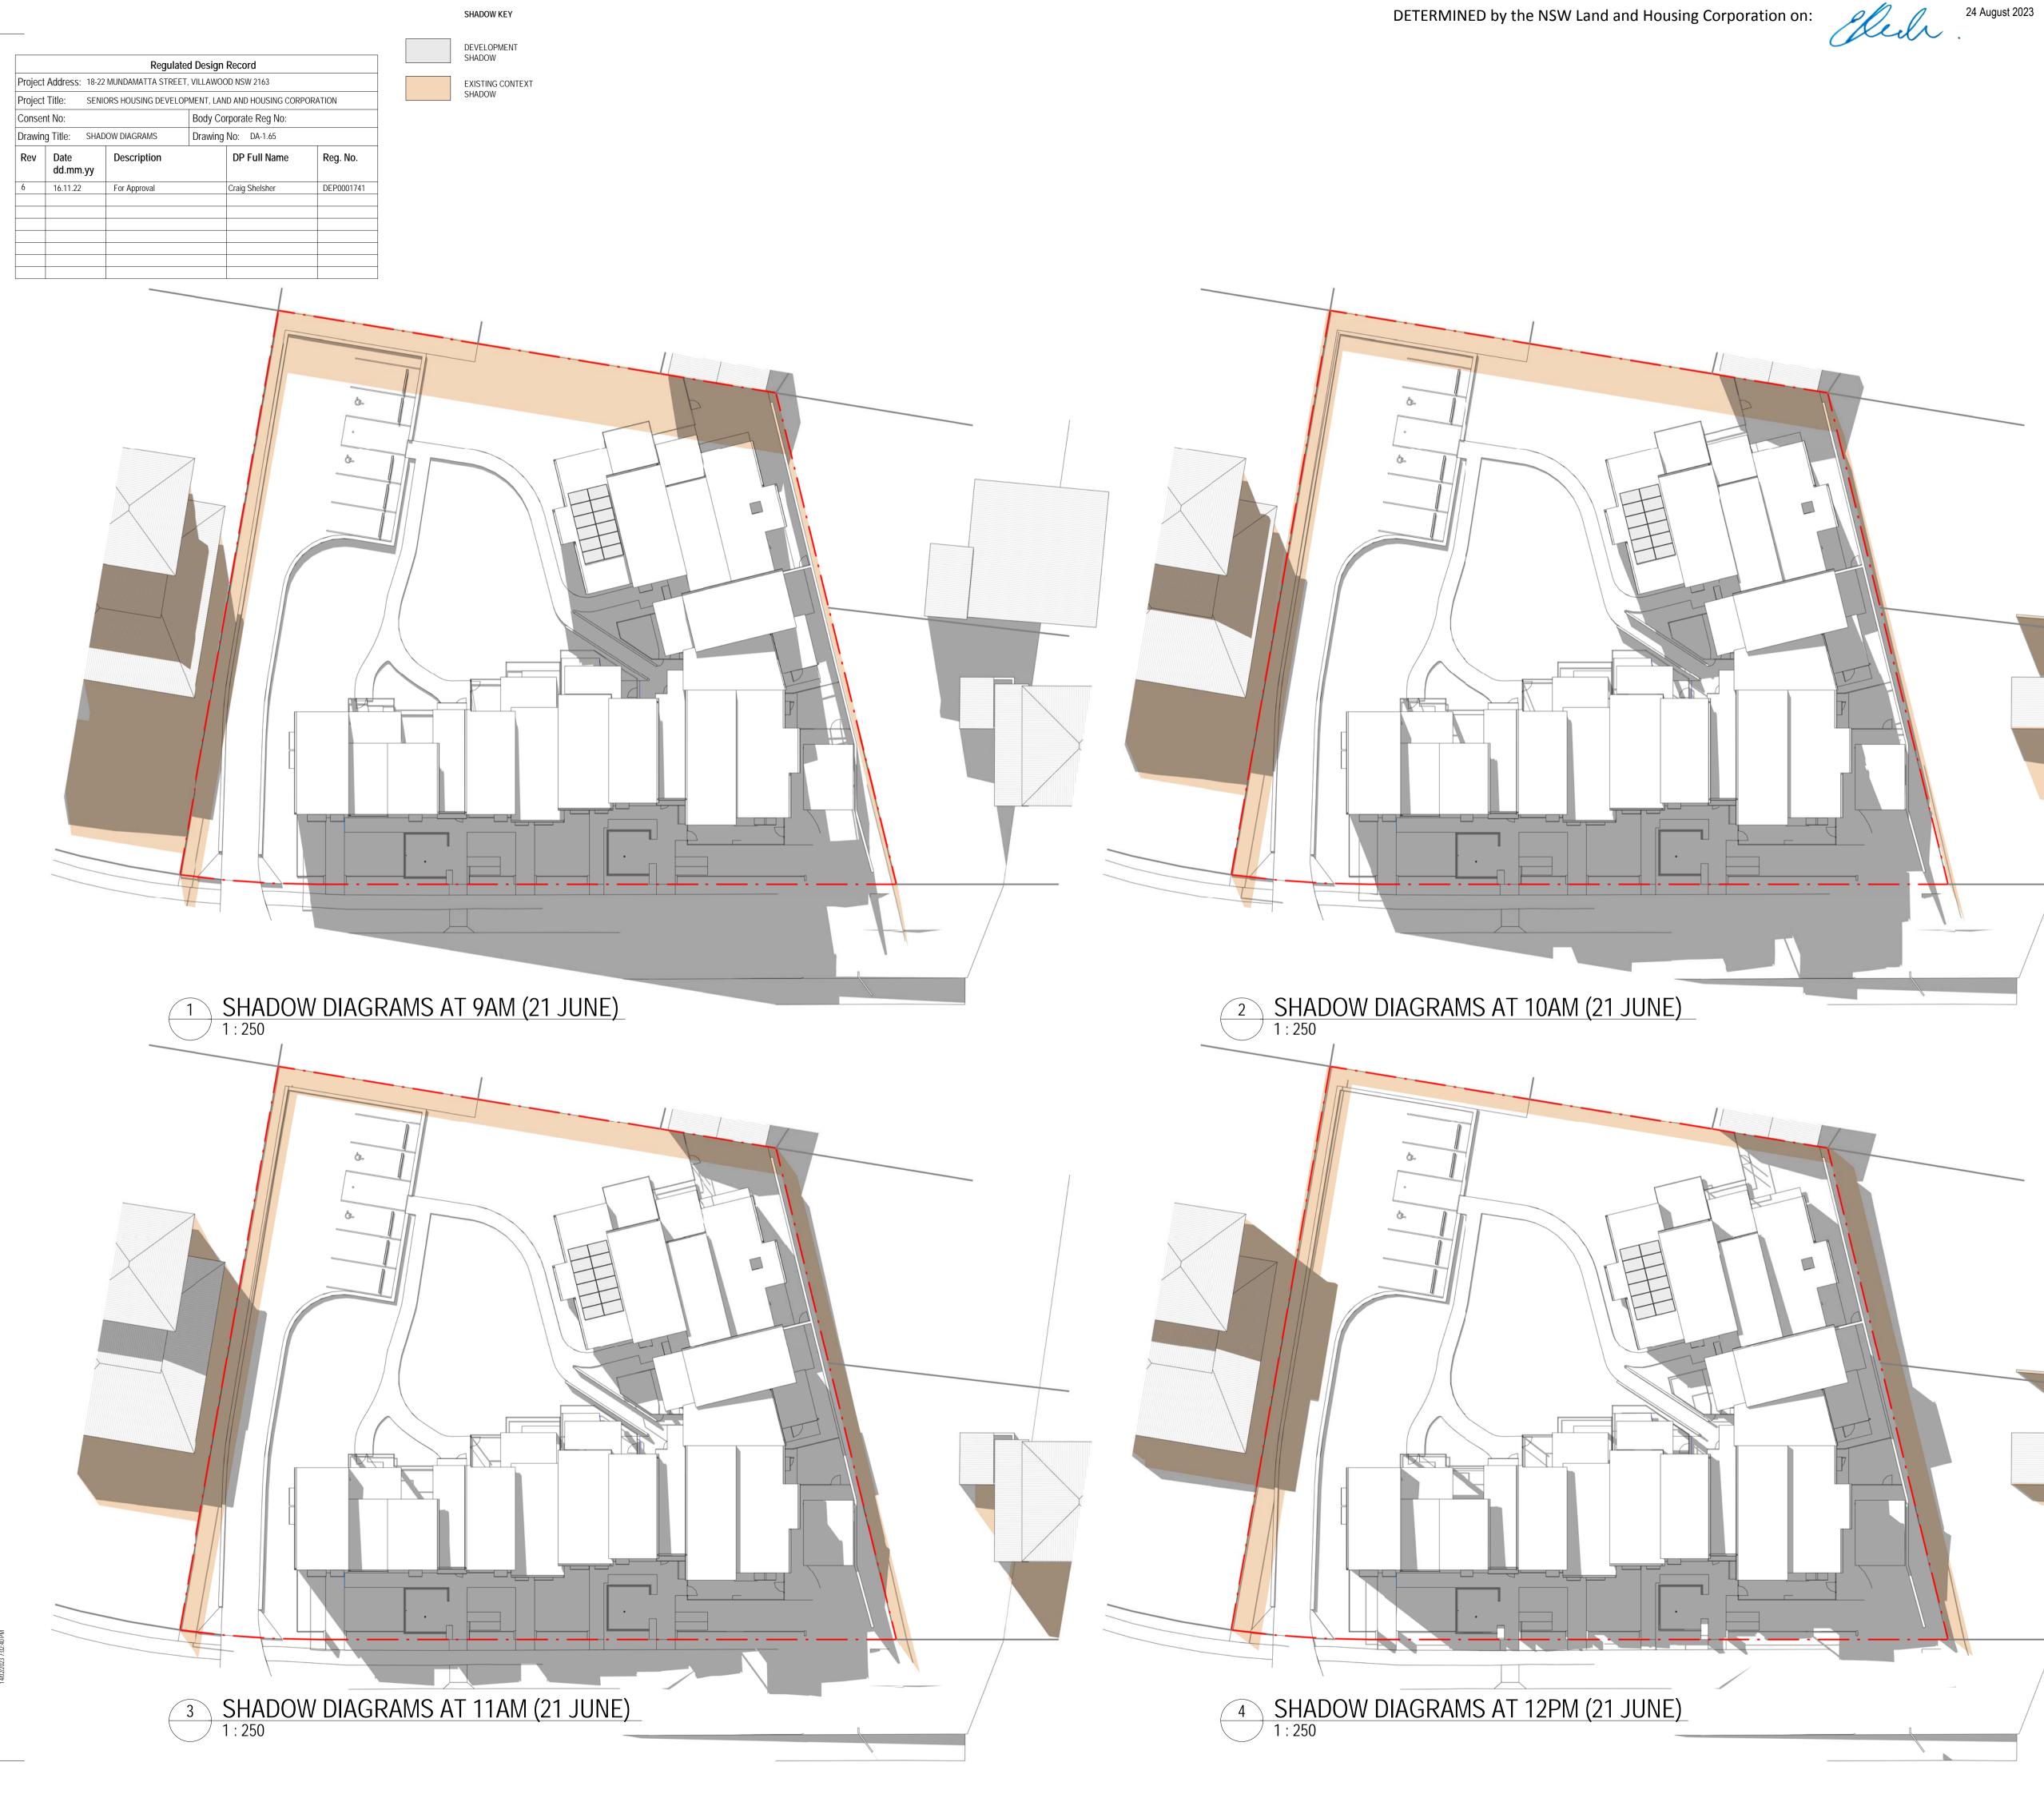

Revision Description

Revision	Description	Date
1	For Coordination	12/07/22
2	Progress Issue	28/07/22
3	Stage B Submission	05/08/22
4	For Approval	16/09/22
5	DA Issue	26/10/22
6	Part 5 Application	16/11/22
7	Stage 5 Approval- Addendum	17/11/22

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Surry Hills, NSW 2010 Australia

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18-22 MUNDAMATTA STREET, VILLAWOOD NSW 2163 LOTS 814-816 SENIORS HOUSING DEVELOPMENT

Sheet Title

SHADOW DIAGRAMS



SC

SCALE @ A1 1:250 6.25 12.5M Checked

DA-1.65 7

Scale As indicated @ A1

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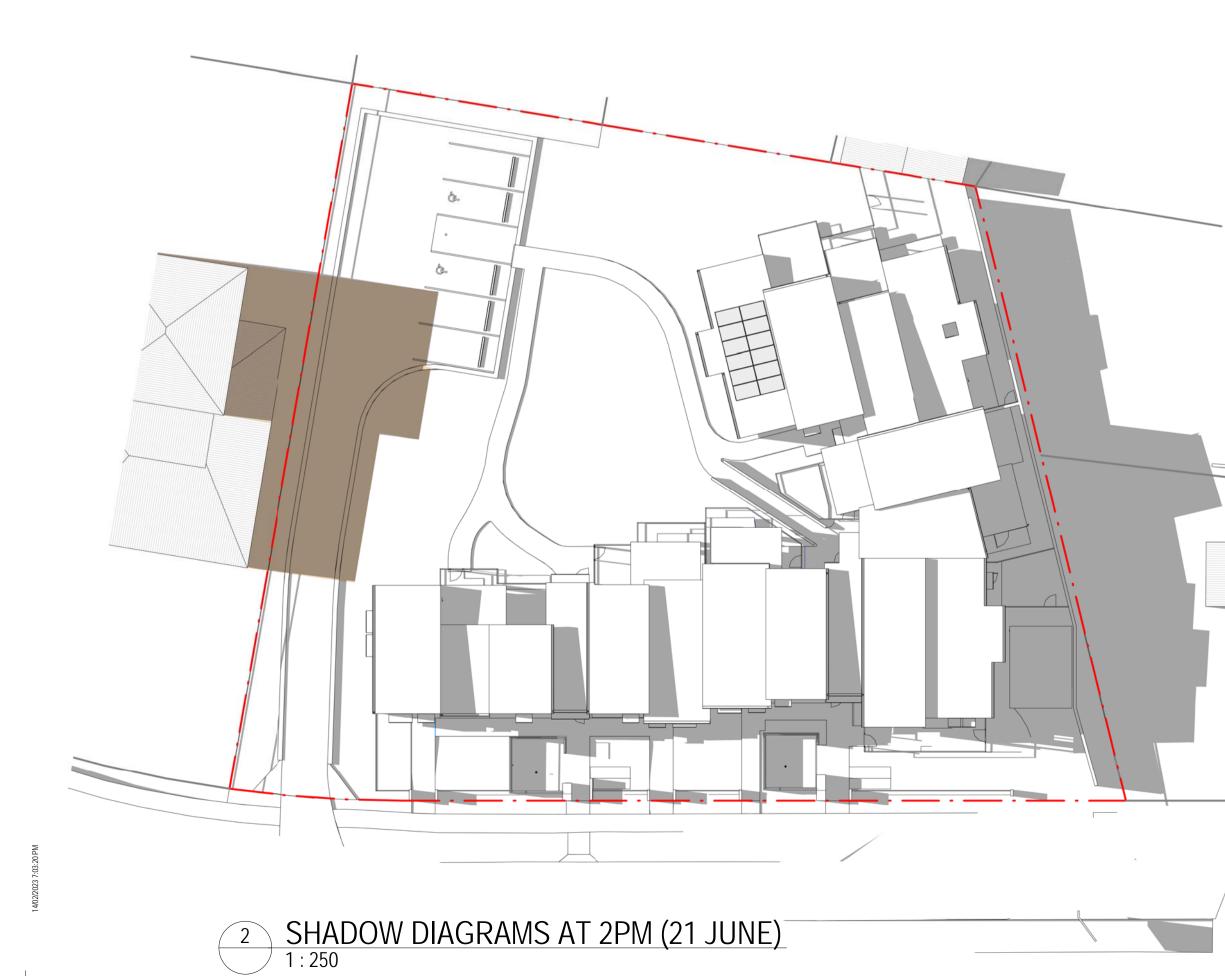
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Sheet No.


SHADOW KEY DEVELOPMENT SHADOW

EXISTING CONTEXT SHADOW

		Regula	ated Design	Record	
Project	Address: 18-22	2 MUNDAMATTA STRE	ET, VILLAWOO	DD NSW 2163	
Project	Title: SENI	ORS HOUSING DEVEL	OPMENT, LAN	ID AND HOUSING CORP	ORATION
Conser	nt No:		Body Co	rporate Reg No:	
Drawing Title: SHADOW DIAGRAMS		Drawing	Drawing No: DA-1.66		
Rev	Date dd.mm.yy	Description		DP Full Name	Reg. No.
6	16.11.22	For Approval	For Approval		DEP0001741



DETERMINED by the NSW Land and Housing Corporation on: 24 August 2023

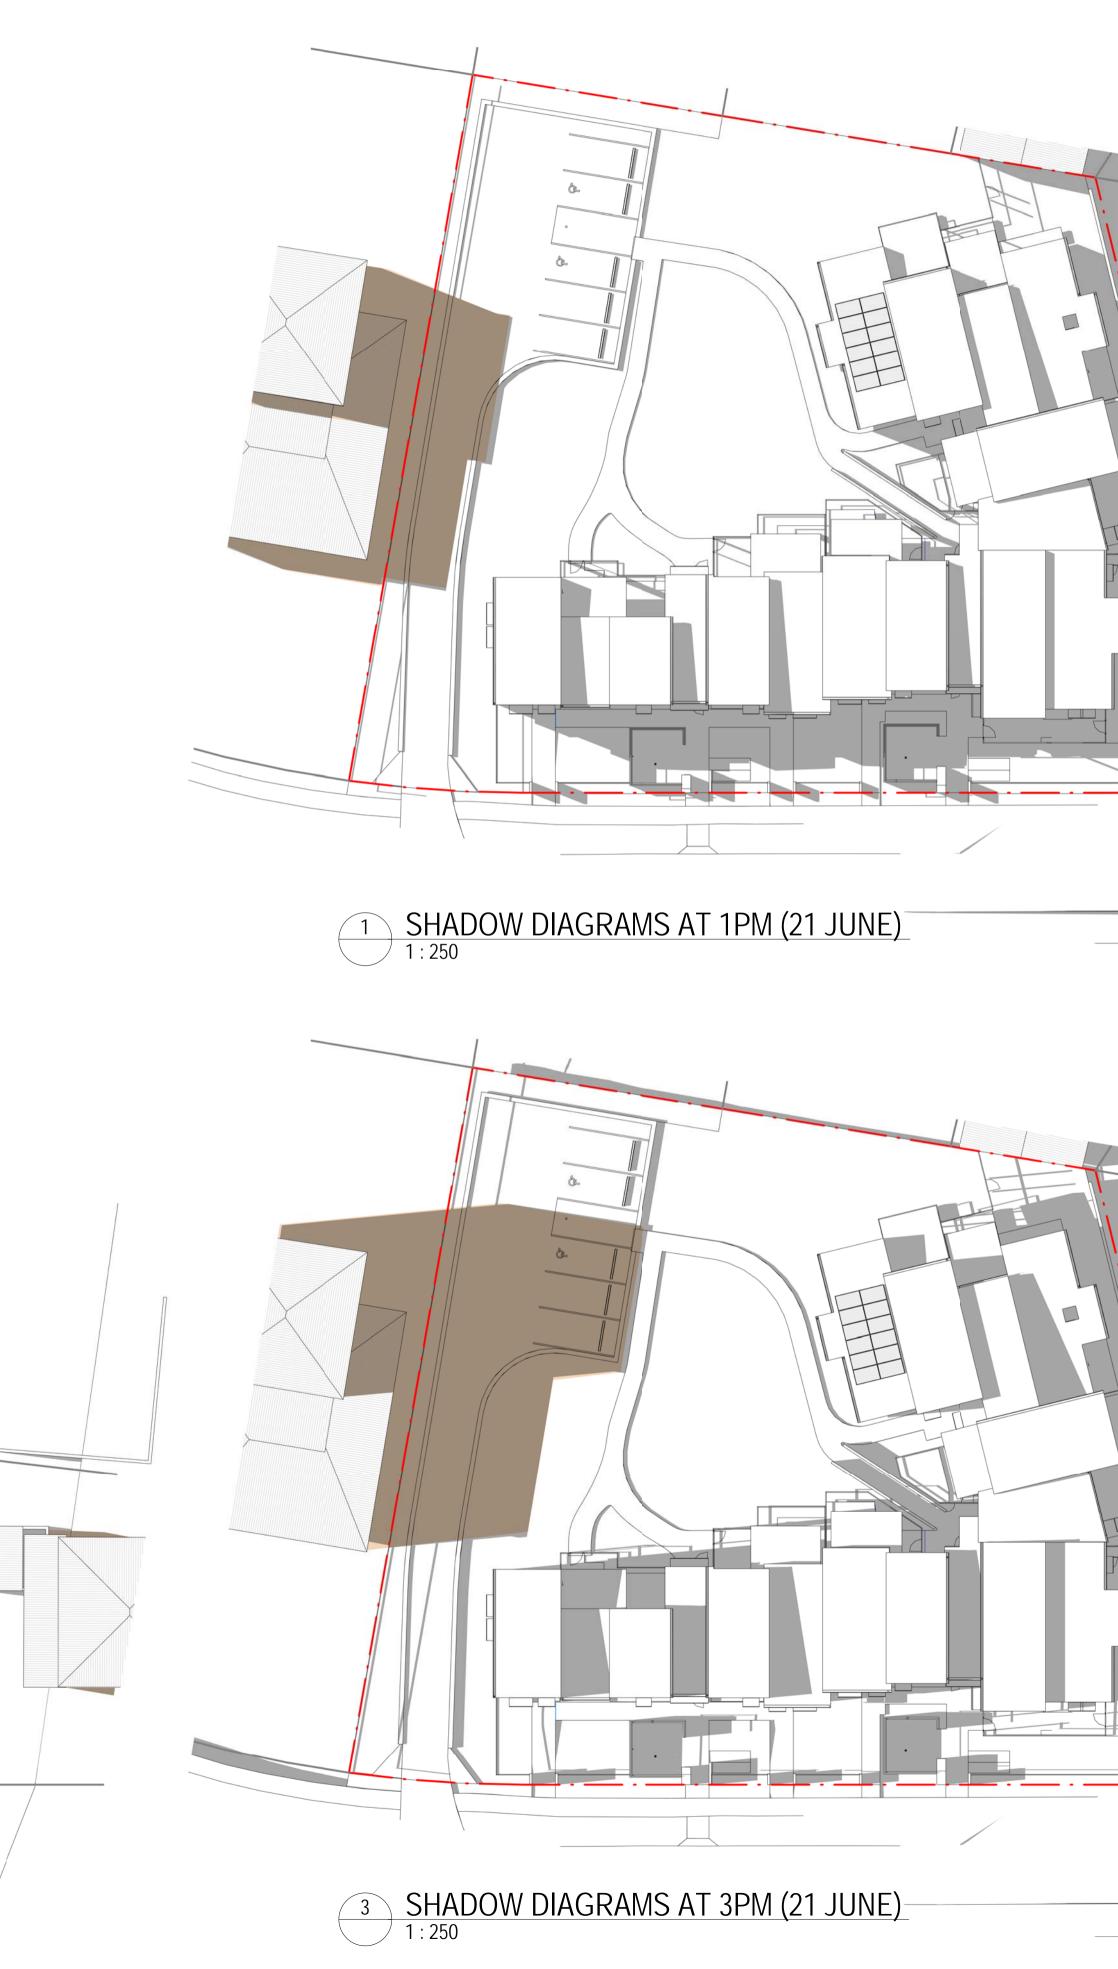

Dovicion Decoription

Revision	Description	Date
1	For Coordination	12/07/22
2	Progress Issue	28/07/22
3	Stage B Submission	05/08/22
4	For Approval	16/09/22
5	DA Issue	26/10/22
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7	Stage 5 Approval- Addendum	17/11/22



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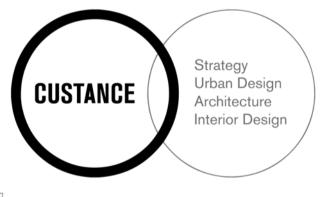
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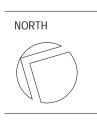
Australia

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18-22 MUNDAMATTA STREET, VILLAWOOD NSW 2163 LOTS 814-816 SENIORS HOUSING DEVELOPMENT

Sheet Title

SHADOW DIAGRAMS



Drawr

SC

SCALE @ A1 1:250 6.25 12.5M 0

DA-1.66 7



Revision

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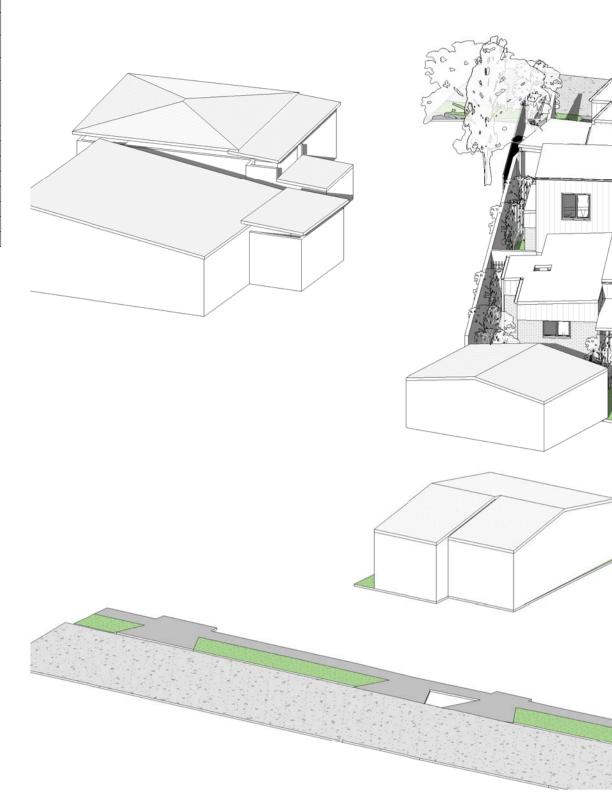
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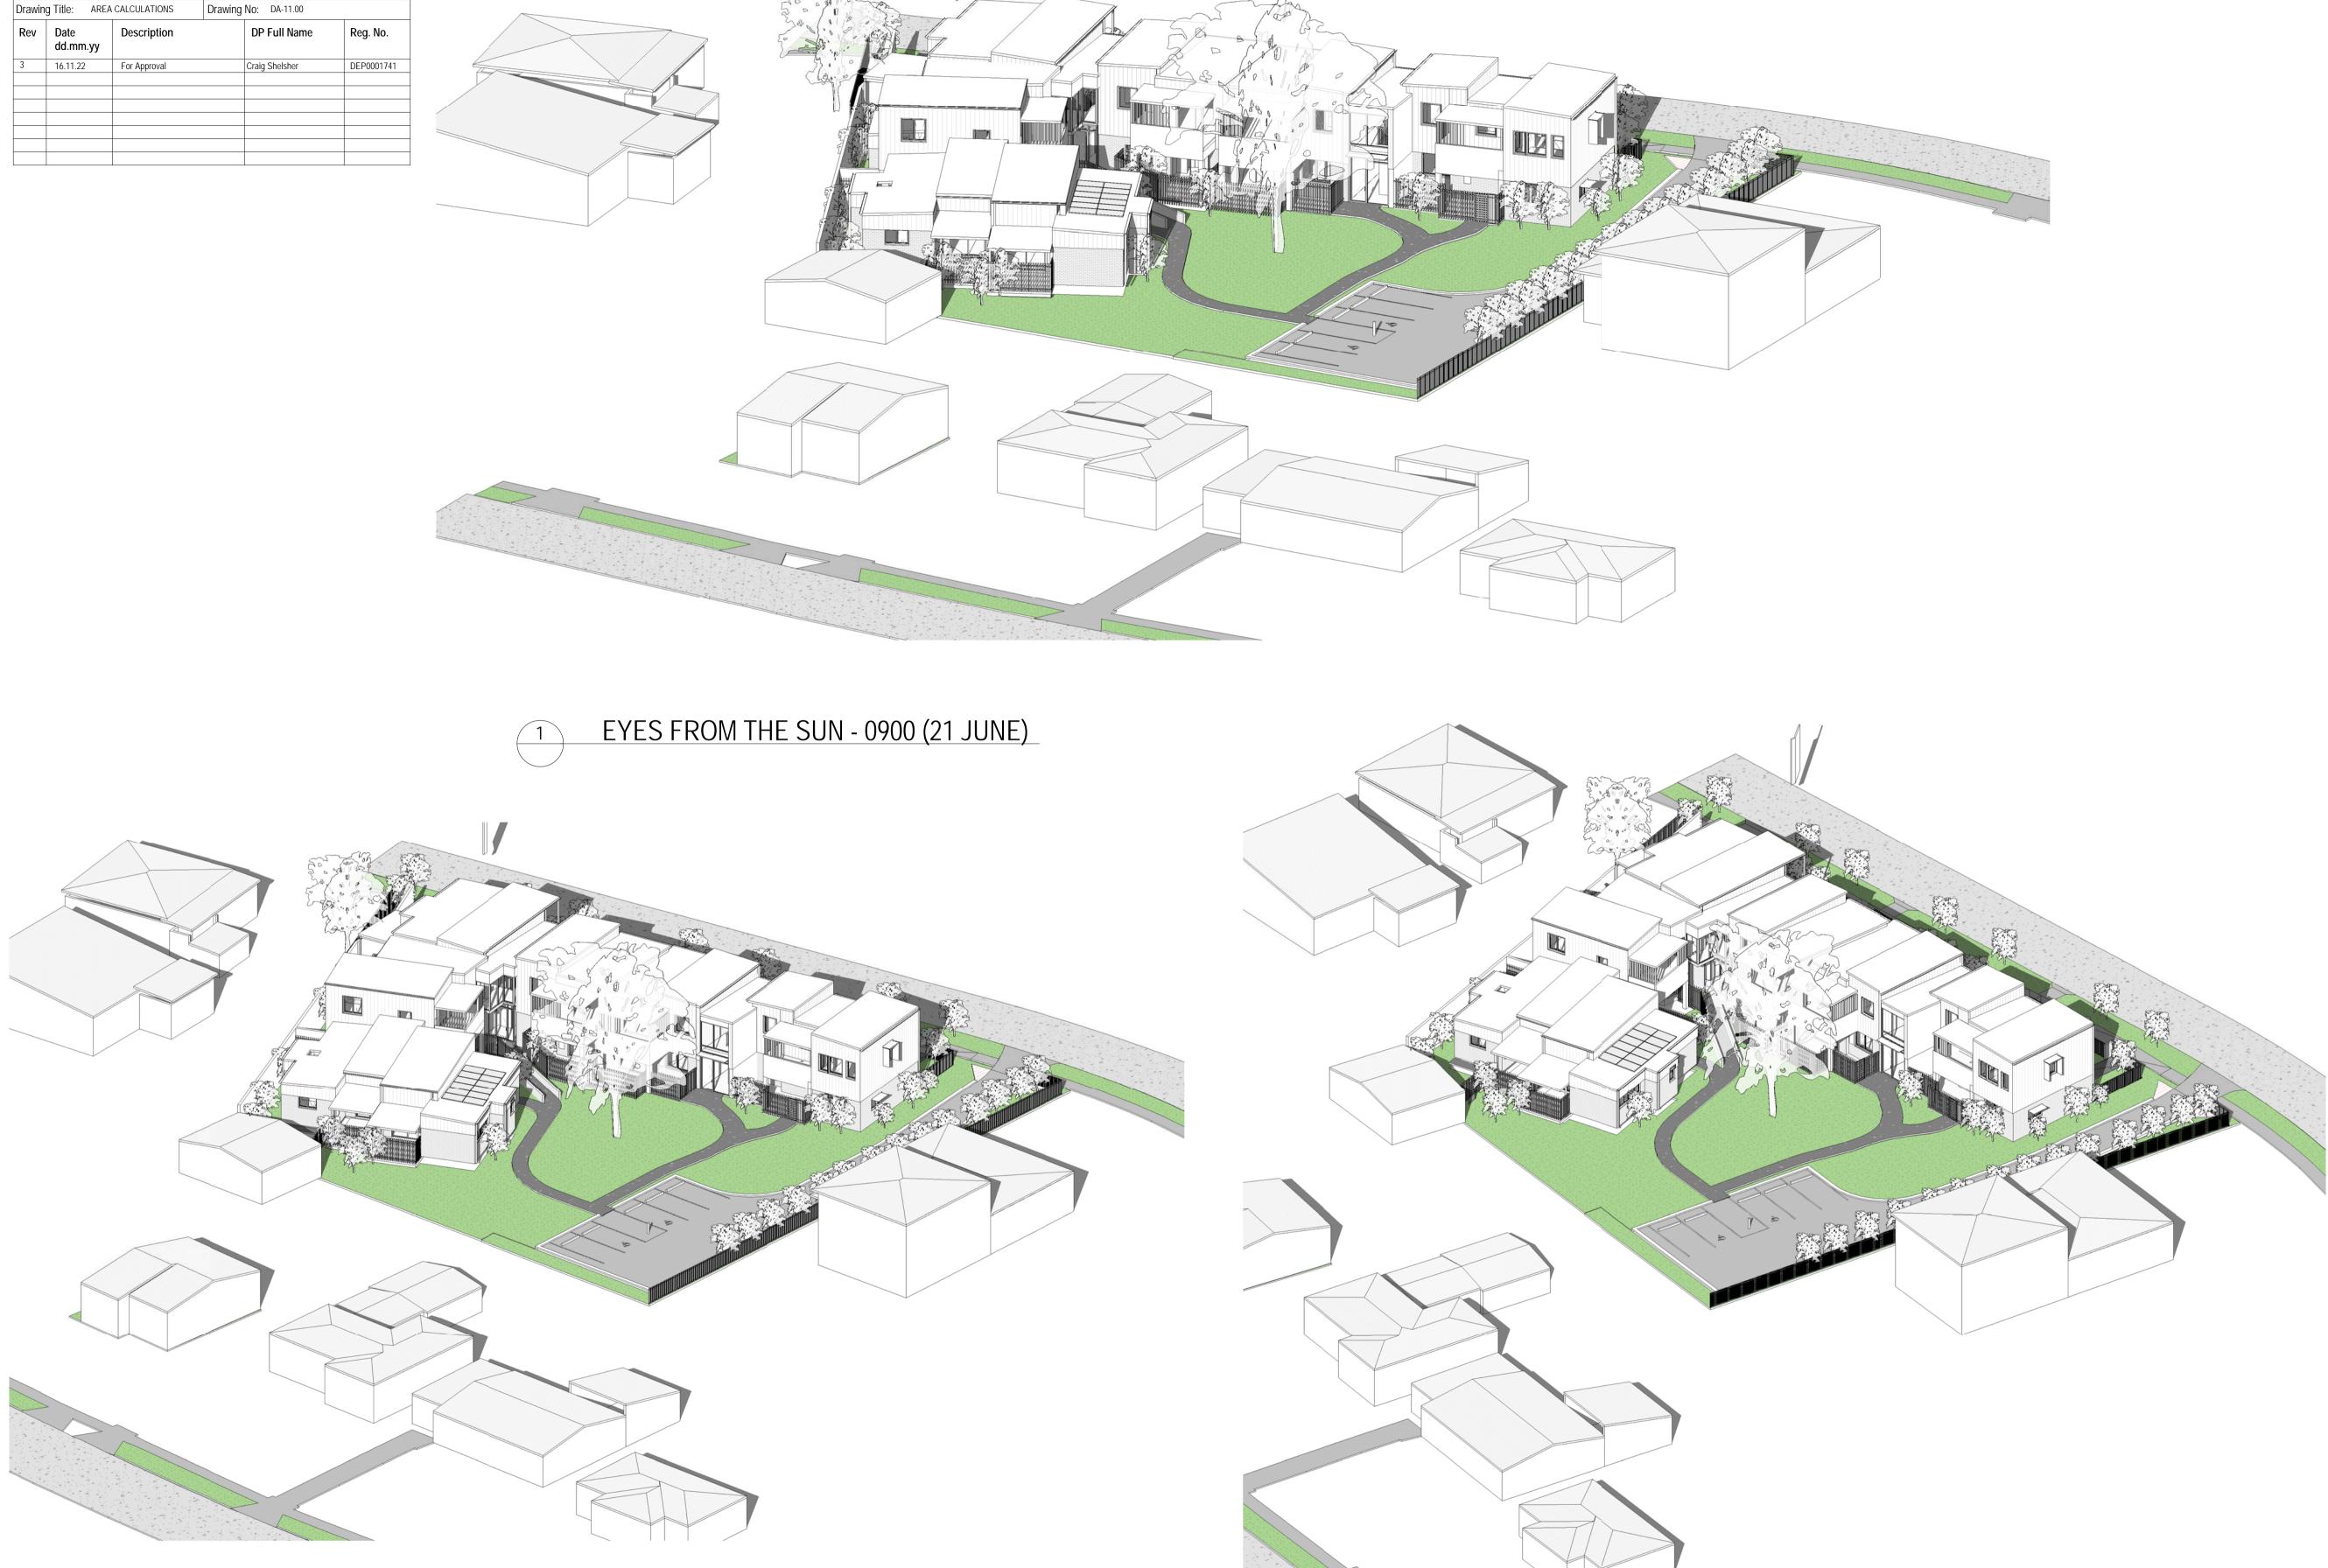
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		Regula	ted Design	Record	
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Project	Title: SEN	ORS HOUSING DEVEL	OPMENT, LAN	ID AND HOUSING CORP	ORATION
Conser	nt No:		Body Co	rporate Reg No:	
Drawing Title: AREA CALCULATIONS		CALCULATIONS	Drawing	No: DA-11.00	
Rev	Date dd.mm.yy	Description		DP Full Name	Reg. No.
3	16.11.22	For Approval		Craig Shelsher	DEP0001741











EYES FROM THE SUN - 1100 (21 JUNE)

Revision	Description	Date
1	Stage B Submission	05/08/22
2	For Approval	16/09/22
3	Part 5 Application	16/11/22
4	Stage 5 Approval- Addendum	17/11/22

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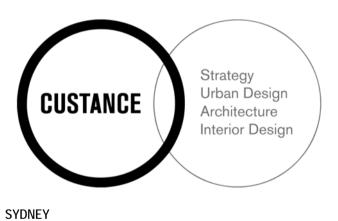
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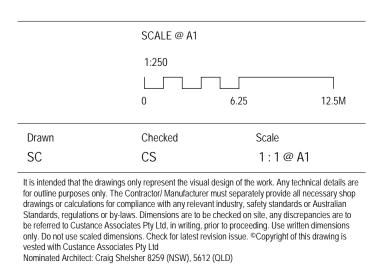
Australia

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Project 18-22 MUNDAMATTA STREET, VILLAWOOD NSW 2163 LOTS 814-816 SENIORS HOUSING DEVELOPMENT

Sheet Title

EYES FROM THE SUN




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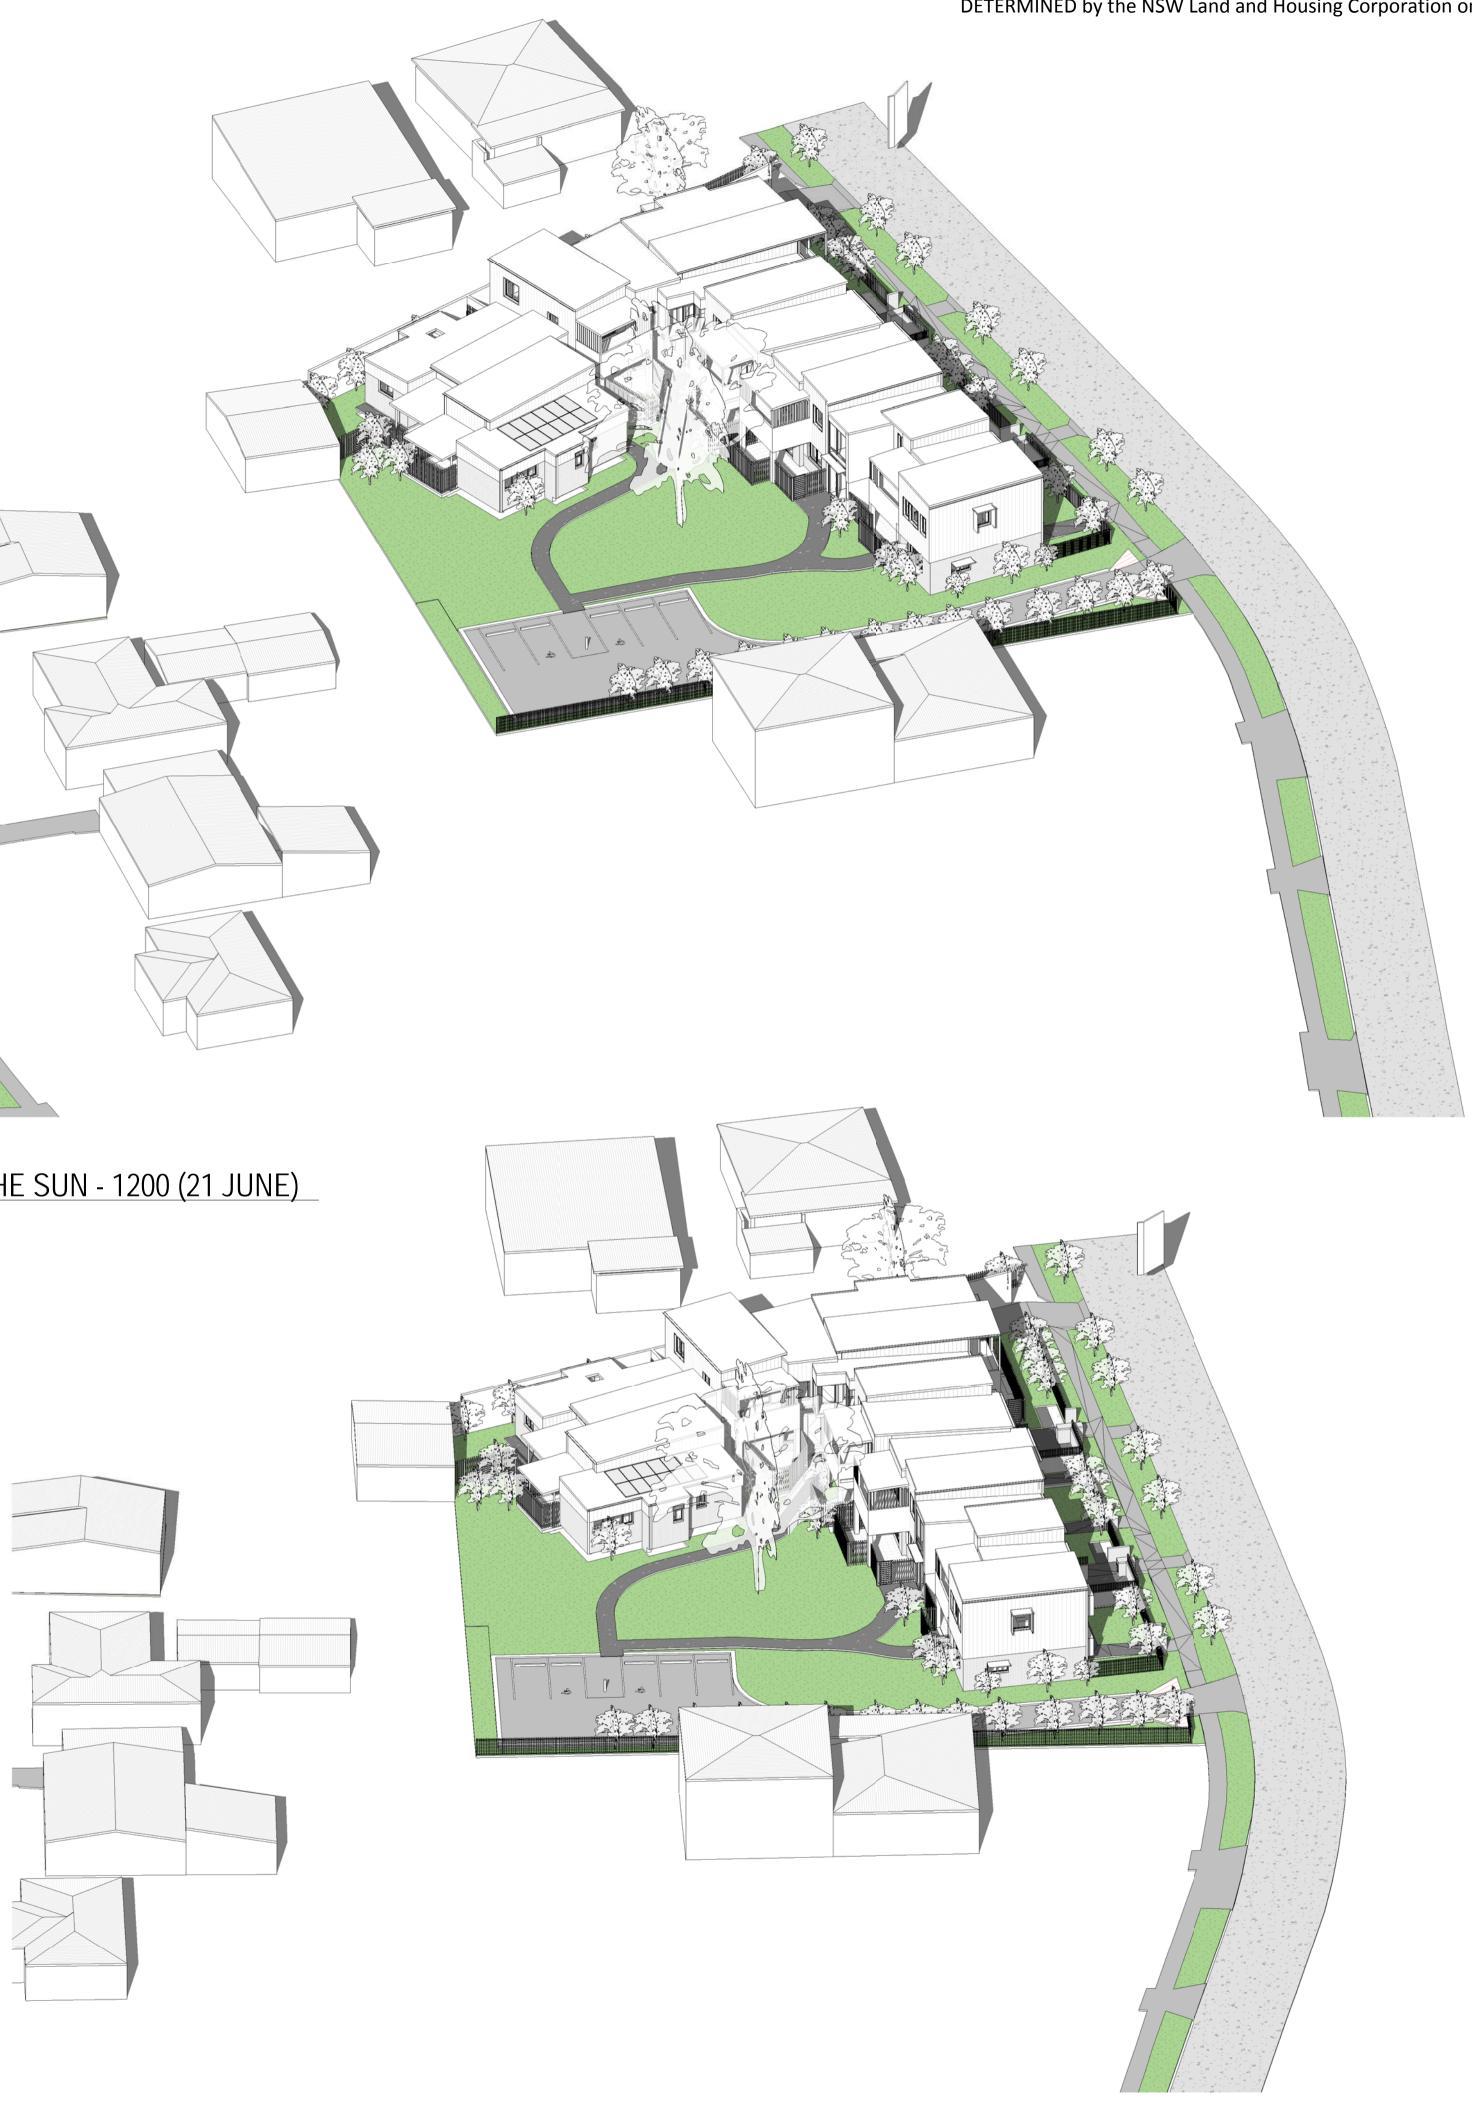
DA-1.68

Revision

4

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Project	Title: SEN	ORS HOUSING DEVELOR	PMENT, LAN	D AND HOUSING CORP	ORATION
Conser	nt No:		Body Co	rporate Reg No:	
Drawing	g Title: AREA	CALCULATIONS	Drawing	No: DA-11.00	
Rev	Date dd.mm.yy	Description		DP Full Name	Reg. No.
3	16.11.22	For Approval		Craig Shelsher	DEP0001741



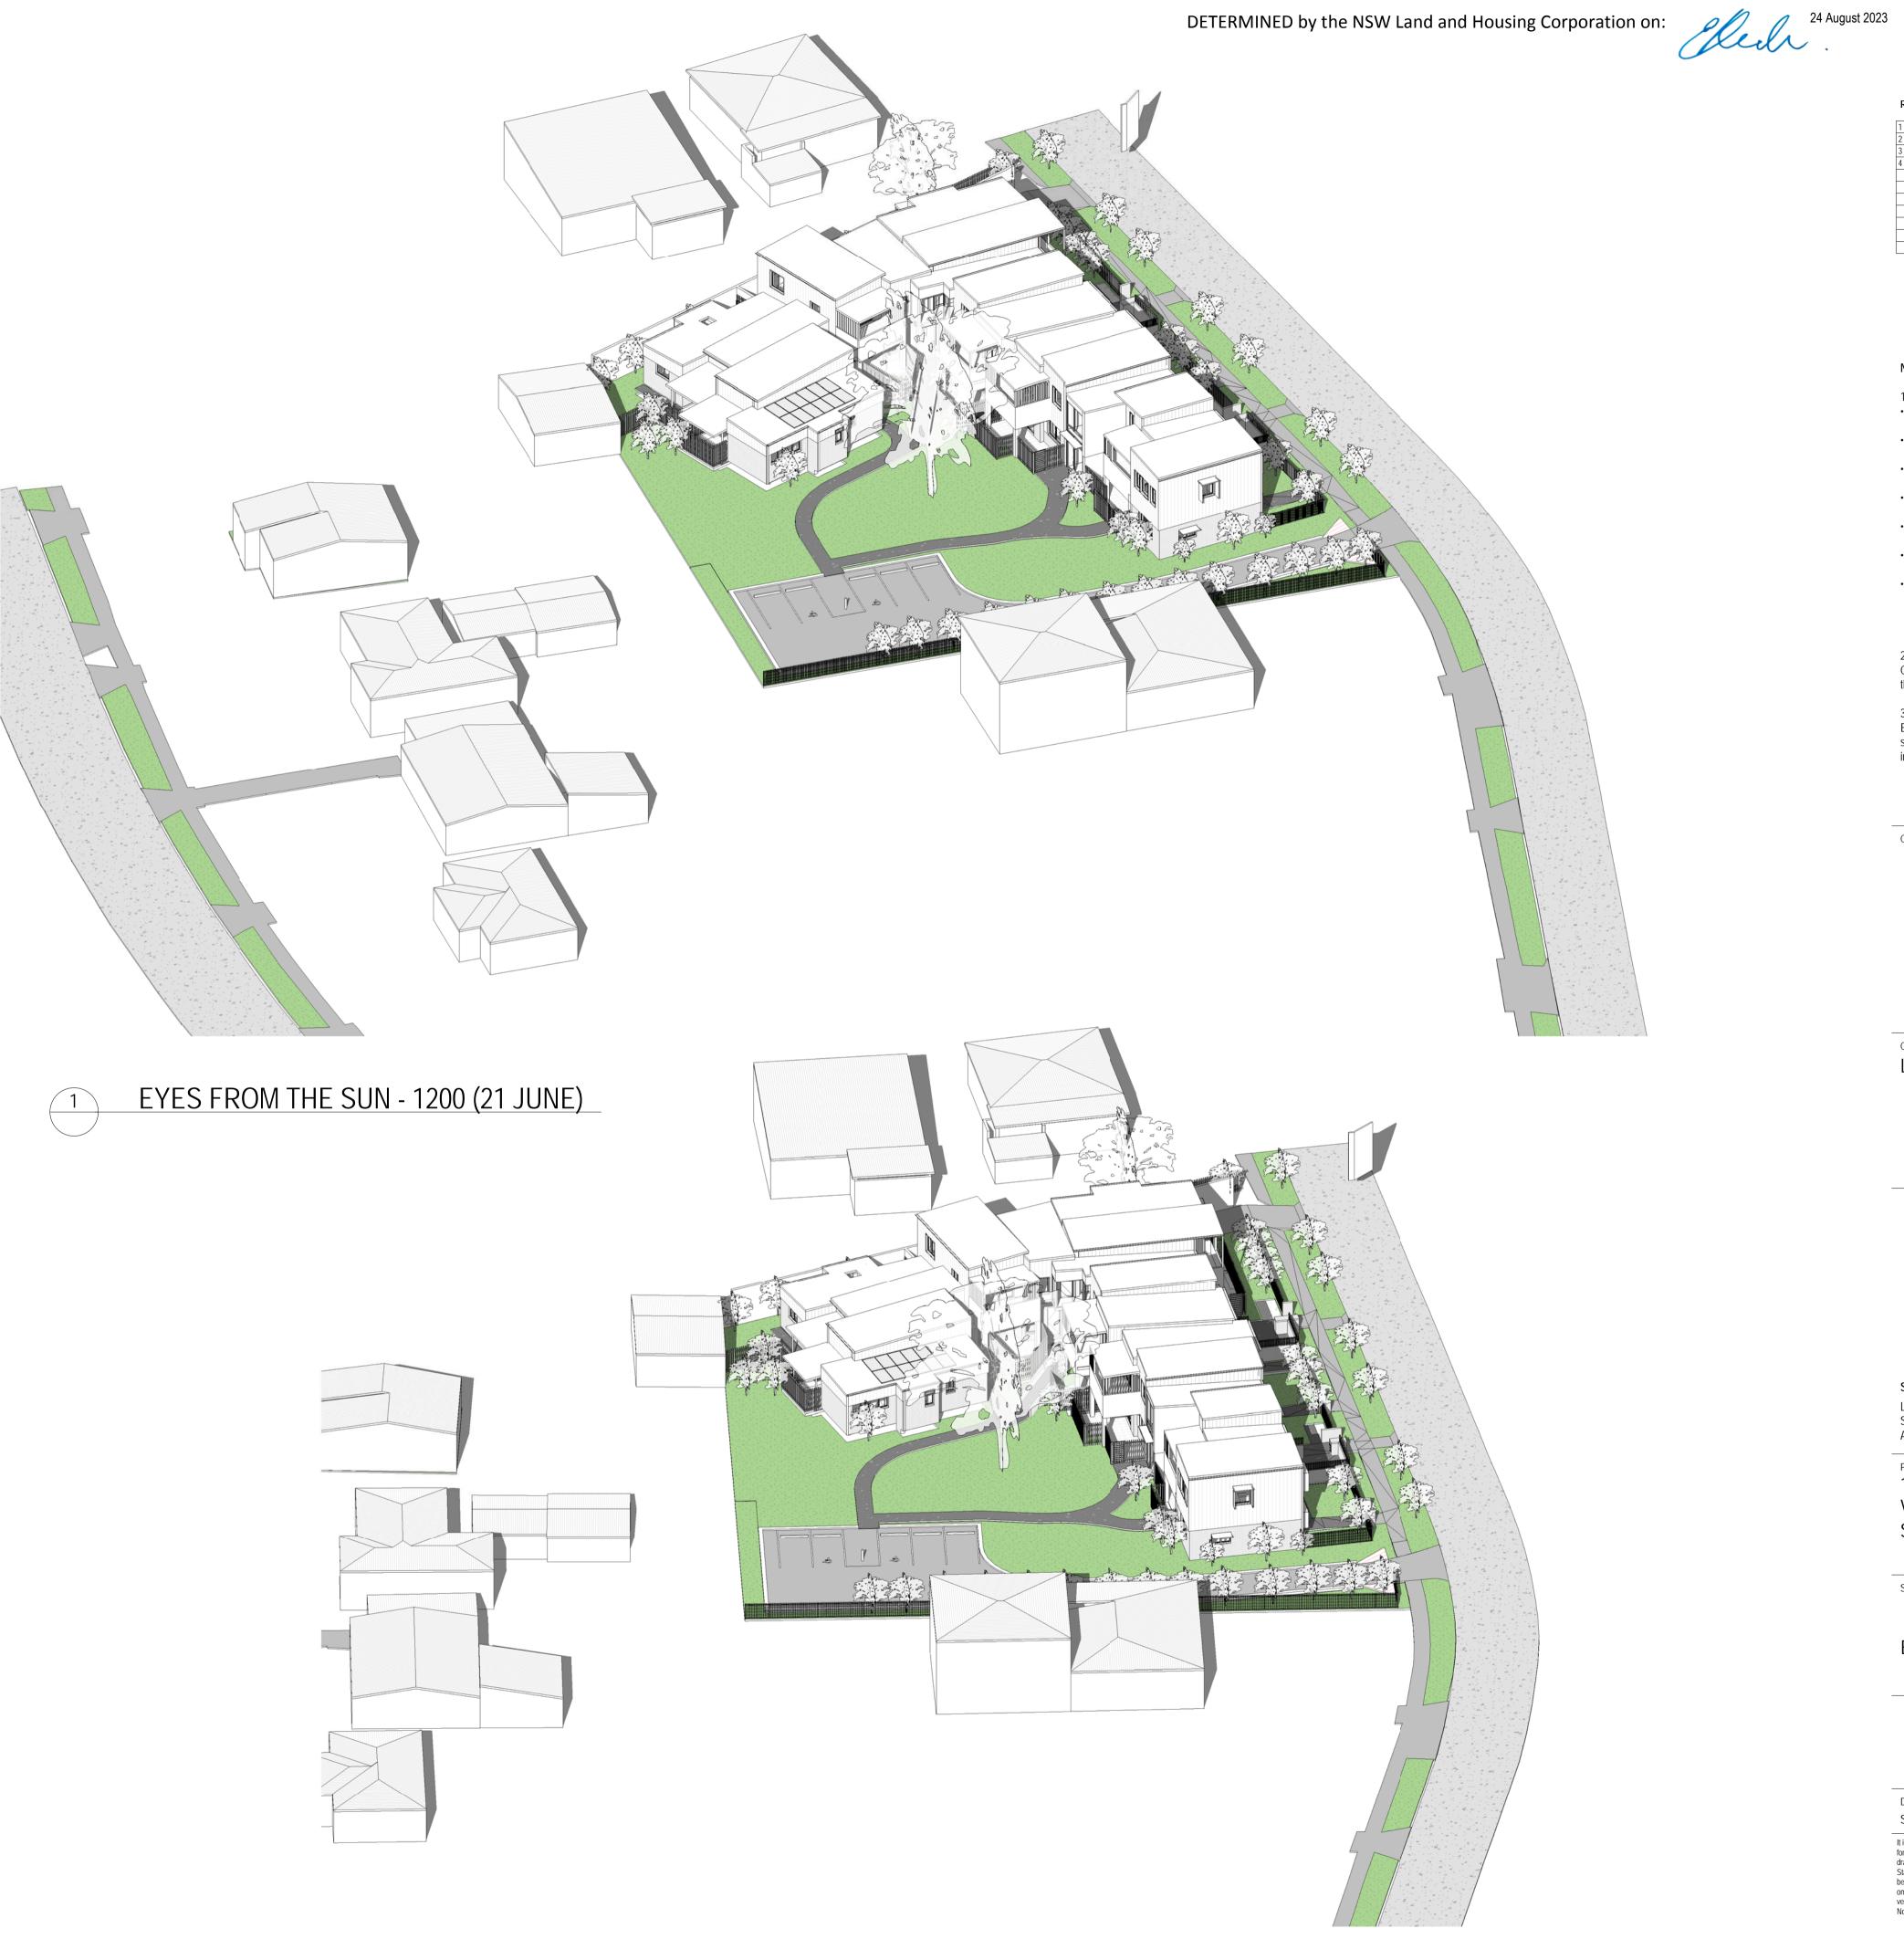





Revision Description

Revision	Description	Date
1	Stage B Submission	05/08/22
2	For Approval	16/09/22
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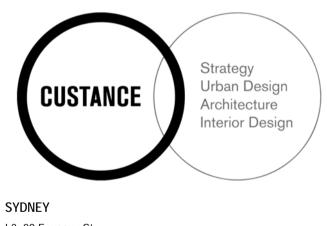
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Consultants

Client LAND AND HOUSING CORPORATION




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Project 18-22 MUNDAMATTA STREET, VILLAWOOD NSW 2163 LOTS 814-816 SENIORS HOUSING DEVELOPMENT

Sheet Title

EYES FROM THE SUN





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Sheet No. DA-1.69 Revision

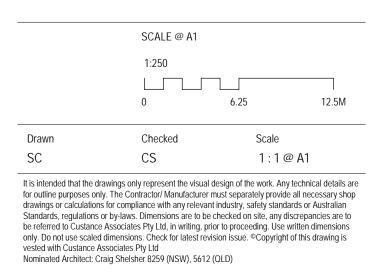
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		Regulat	ed Design	Record	
Project	Address: 18-22	MUNDAMATTA STREE	T, VILLAWOO	DD NSW 2163	
Project	Title: SENI	ORS HOUSING DEVELO	OPMENT, LAN	ID AND HOUSING CORP	ORATION
Conser	it No:		Body Co	rporate Reg No:	
Drawing	g Title: AREA	CALCULATIONS	Drawing	No: DA-11.00	
Rev	Date dd.mm.yy	Description	·	DP Full Name	Reg. No.
3	16.11.22	For Approval		Craig Shelsher	DEP0001741





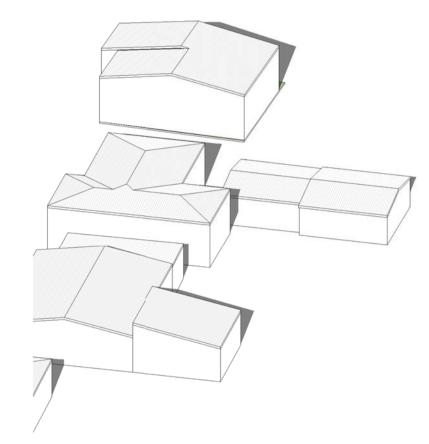

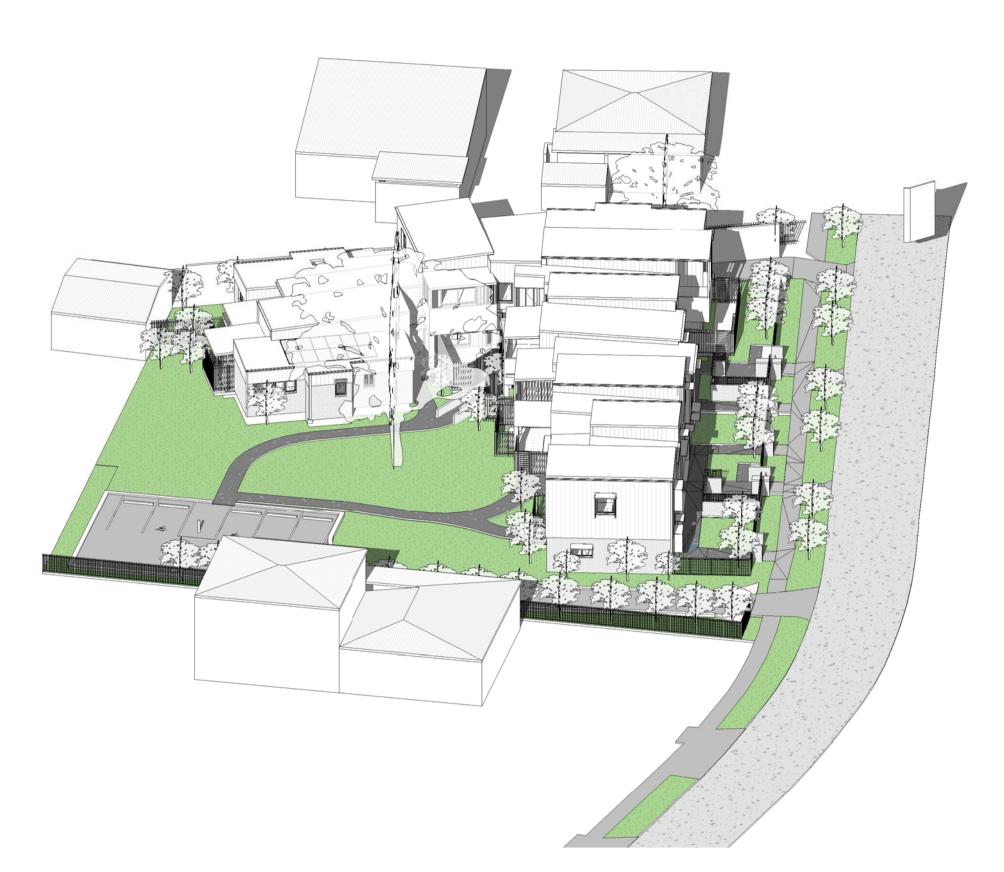

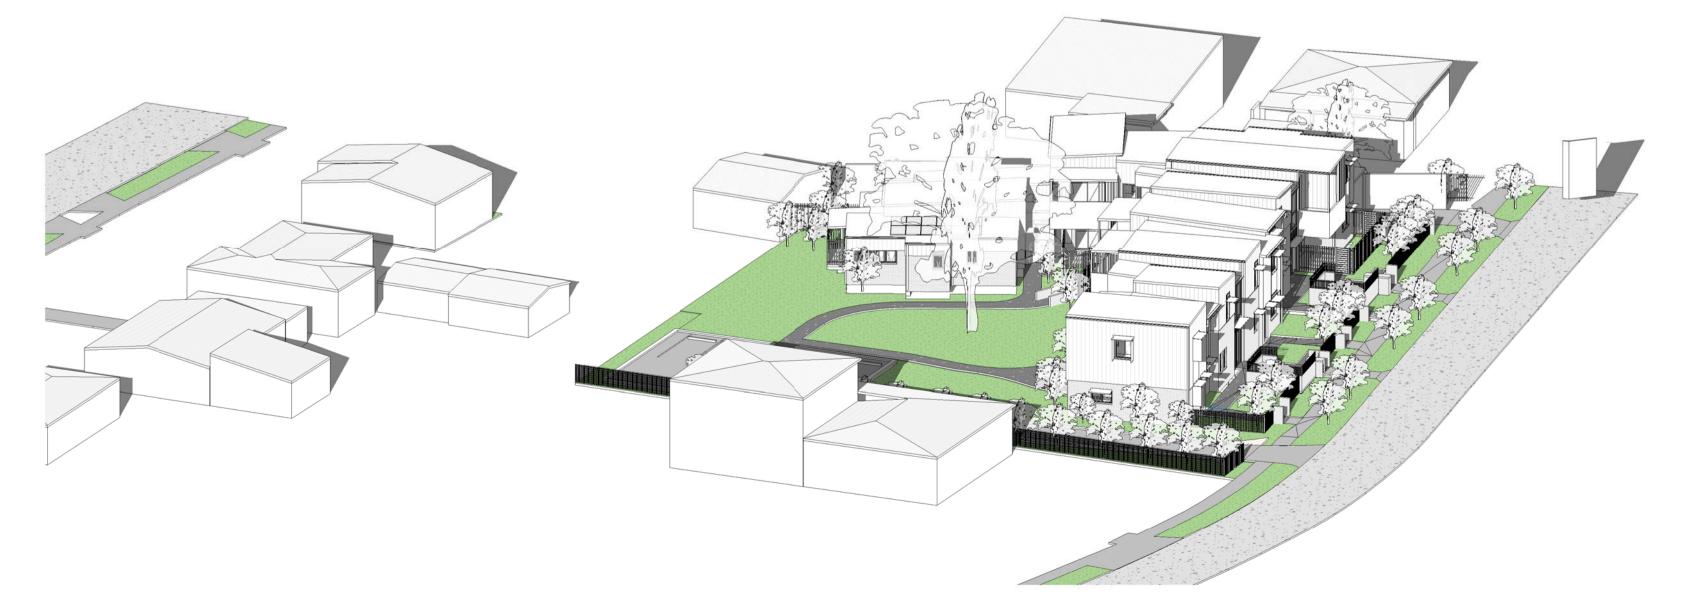2

		SOLAR ACCE	SS TABLE	
UNIT No.	LOUNGE	SOLAR ACCESS	POS	SOLAR ACCESS
	ROOM			
UNIT 1	9am -12 noon	3hrs - complies with SEPP	11am - 1pm	2hrs - complies with SI
UNIT 2	9am -11am	2hrs - complies with SEPP	11am - 3pm	4hrs - complies with St
UNIT 3	9am -11am	2hrs - complies with SEPP	11am - 3pm	4hrs - complies with SI
UNIT 4		Non compliant	2pm- 3pm	Non compliant
UNIT 5	1pm - 3pm	2hrs- complies with SEPP	12 noon - 3pm	3hrs - complies with SI
UNIT 6	9am -12 noon	3hrs - complies with SEPP	9am- 2pm	5hrs - complies with SI
UNIT 7	9am -12 noon	3hrs - complies with SEPP	9am -3pm	6hrs - complies with SI
UNIT 8	9am - 12 noon	3hrs - complies with SEPP	11am - 1pm	2hrs- complies with SE
UNIT 9	9am - 12 noon	3hrs - complies with SEPP	11am - 3pm	4hrs - complies with SI
UNIT 10	9am - 12 noon	3hrs - complies with SEPP	11am - 3pm	4hrs - complies with SI
UNIT 11	-	Non compliant	2pm nominally	Non compliant
UNIT 12	11am - 3pm	4hrs - complies with SEPP	9am -1pm	4hrs - complies with SI
	10 U	nits achieve SEPP requiremen	ts for (83% of total de	evelopment)
	SEPP re	equirement: min 2hrs solar acco	ess between 9am & 3	3pm mid- winter
No. 14	9am – 2pm	5hrs - complies with SEPP	9am -1pm	4hrs - complies with SI

10am – 2pm 4hrs - complies with SEPP 9am -1pm

Mundamatta St

Mundamatta St

No. 16

Revision	Description	Date
1	Stage B Submission	05/08/22
2	For Approval	16/09/22
3	Part 5 Application	16/11/22
4	Stage 5 Approval- Addendum	17/11/22

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Consultants

Client LAND AND HOUSING CORPORATION




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Project 18-22 MUNDAMATTA STREET, VILLAWOOD NSW 2163 LOTS 814-816 SENIORS HOUSING DEVELOPMENT

Sheet Title

EYES FROM THE SUN



Sheet No.

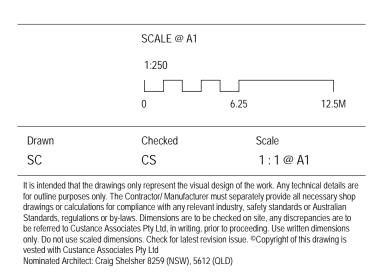DA-1.70

Revision

4

SEPP SEPP SEPP SEPP SEPP SEPP SEPP SEPP SEPP SEPP

SEPP

4hrs - complies with SEPP



		SD SW DR FP	SLIDING DOOR SLIDING WINDOW SWING DOOR FIXED PANEL
EXTI	ERNAL LE	GEND	
TAG	DESCRIPTI	ON	

Revision Description

ICC VISION	Description	Dale
1	For Coordination	12/07/22
2	Progress Issue	28/07/22
3	Stage B Submission	05/08/22
4	For Approval	16/09/22
5	DA Issue	26/10/22
6	Part 5 Application	16/11/22
7	Stage 5 Approval- Addendum	17/11/22
8	Facade & G. Enclosure Update	14/02/23

Date

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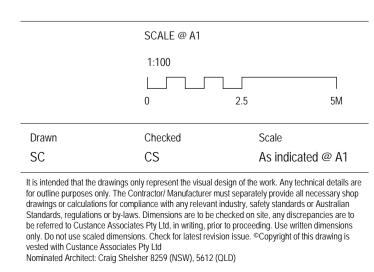
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Project 18-22 MUNDAMATTA STREET, VILLAWOOD NSW 2163 LOTS 814-816 SENIORS HOUSING DEVELOPMENT

Sheet Title

EXTERNAL ELEVATIONS





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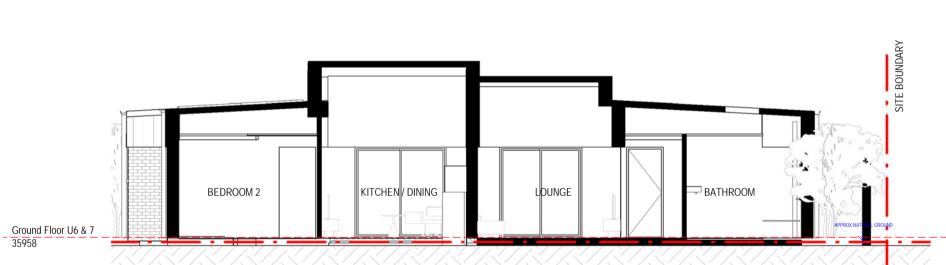
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Revision

1 : 100






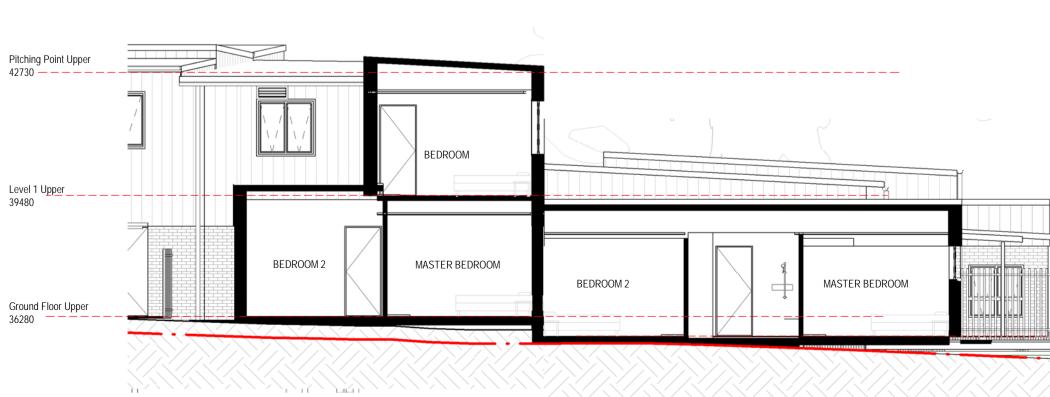

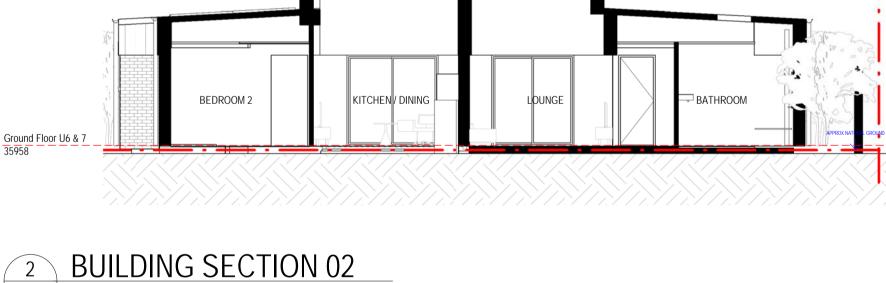



		Regulate	d Design	Record	
Project	Address: 18-22	MUNDAMATTA STREET	, VILLAWOO	DD NSW 2163	
Project	Title: SENI	ORS HOUSING DEVELOP	MENT, LAN	ID AND HOUSING CORP	ORATION
Conser	nt No:		Body Co	rporate Reg No:	
Drawin	g Title: BUILD	DING SECTIONS	Drawing	No: DA-4.00	
Rev	Date dd.mm.yy	Description		DP Full Name	Reg. No.
6	6 16.11.22 For Approval			Craig Shelsher	DEP0001741

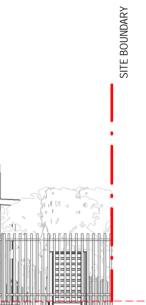

Ground Floor U6 & 7 35958

DETERMINED by the NSW Land and Housing Corporation on: 24 August 2023

Revision	Description	Date
1	For Coordination	12/07/22
2	Progress Issue	28/07/22
3	Stage B Submission	05/08/22
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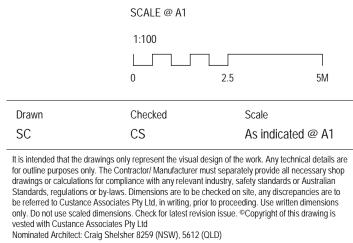
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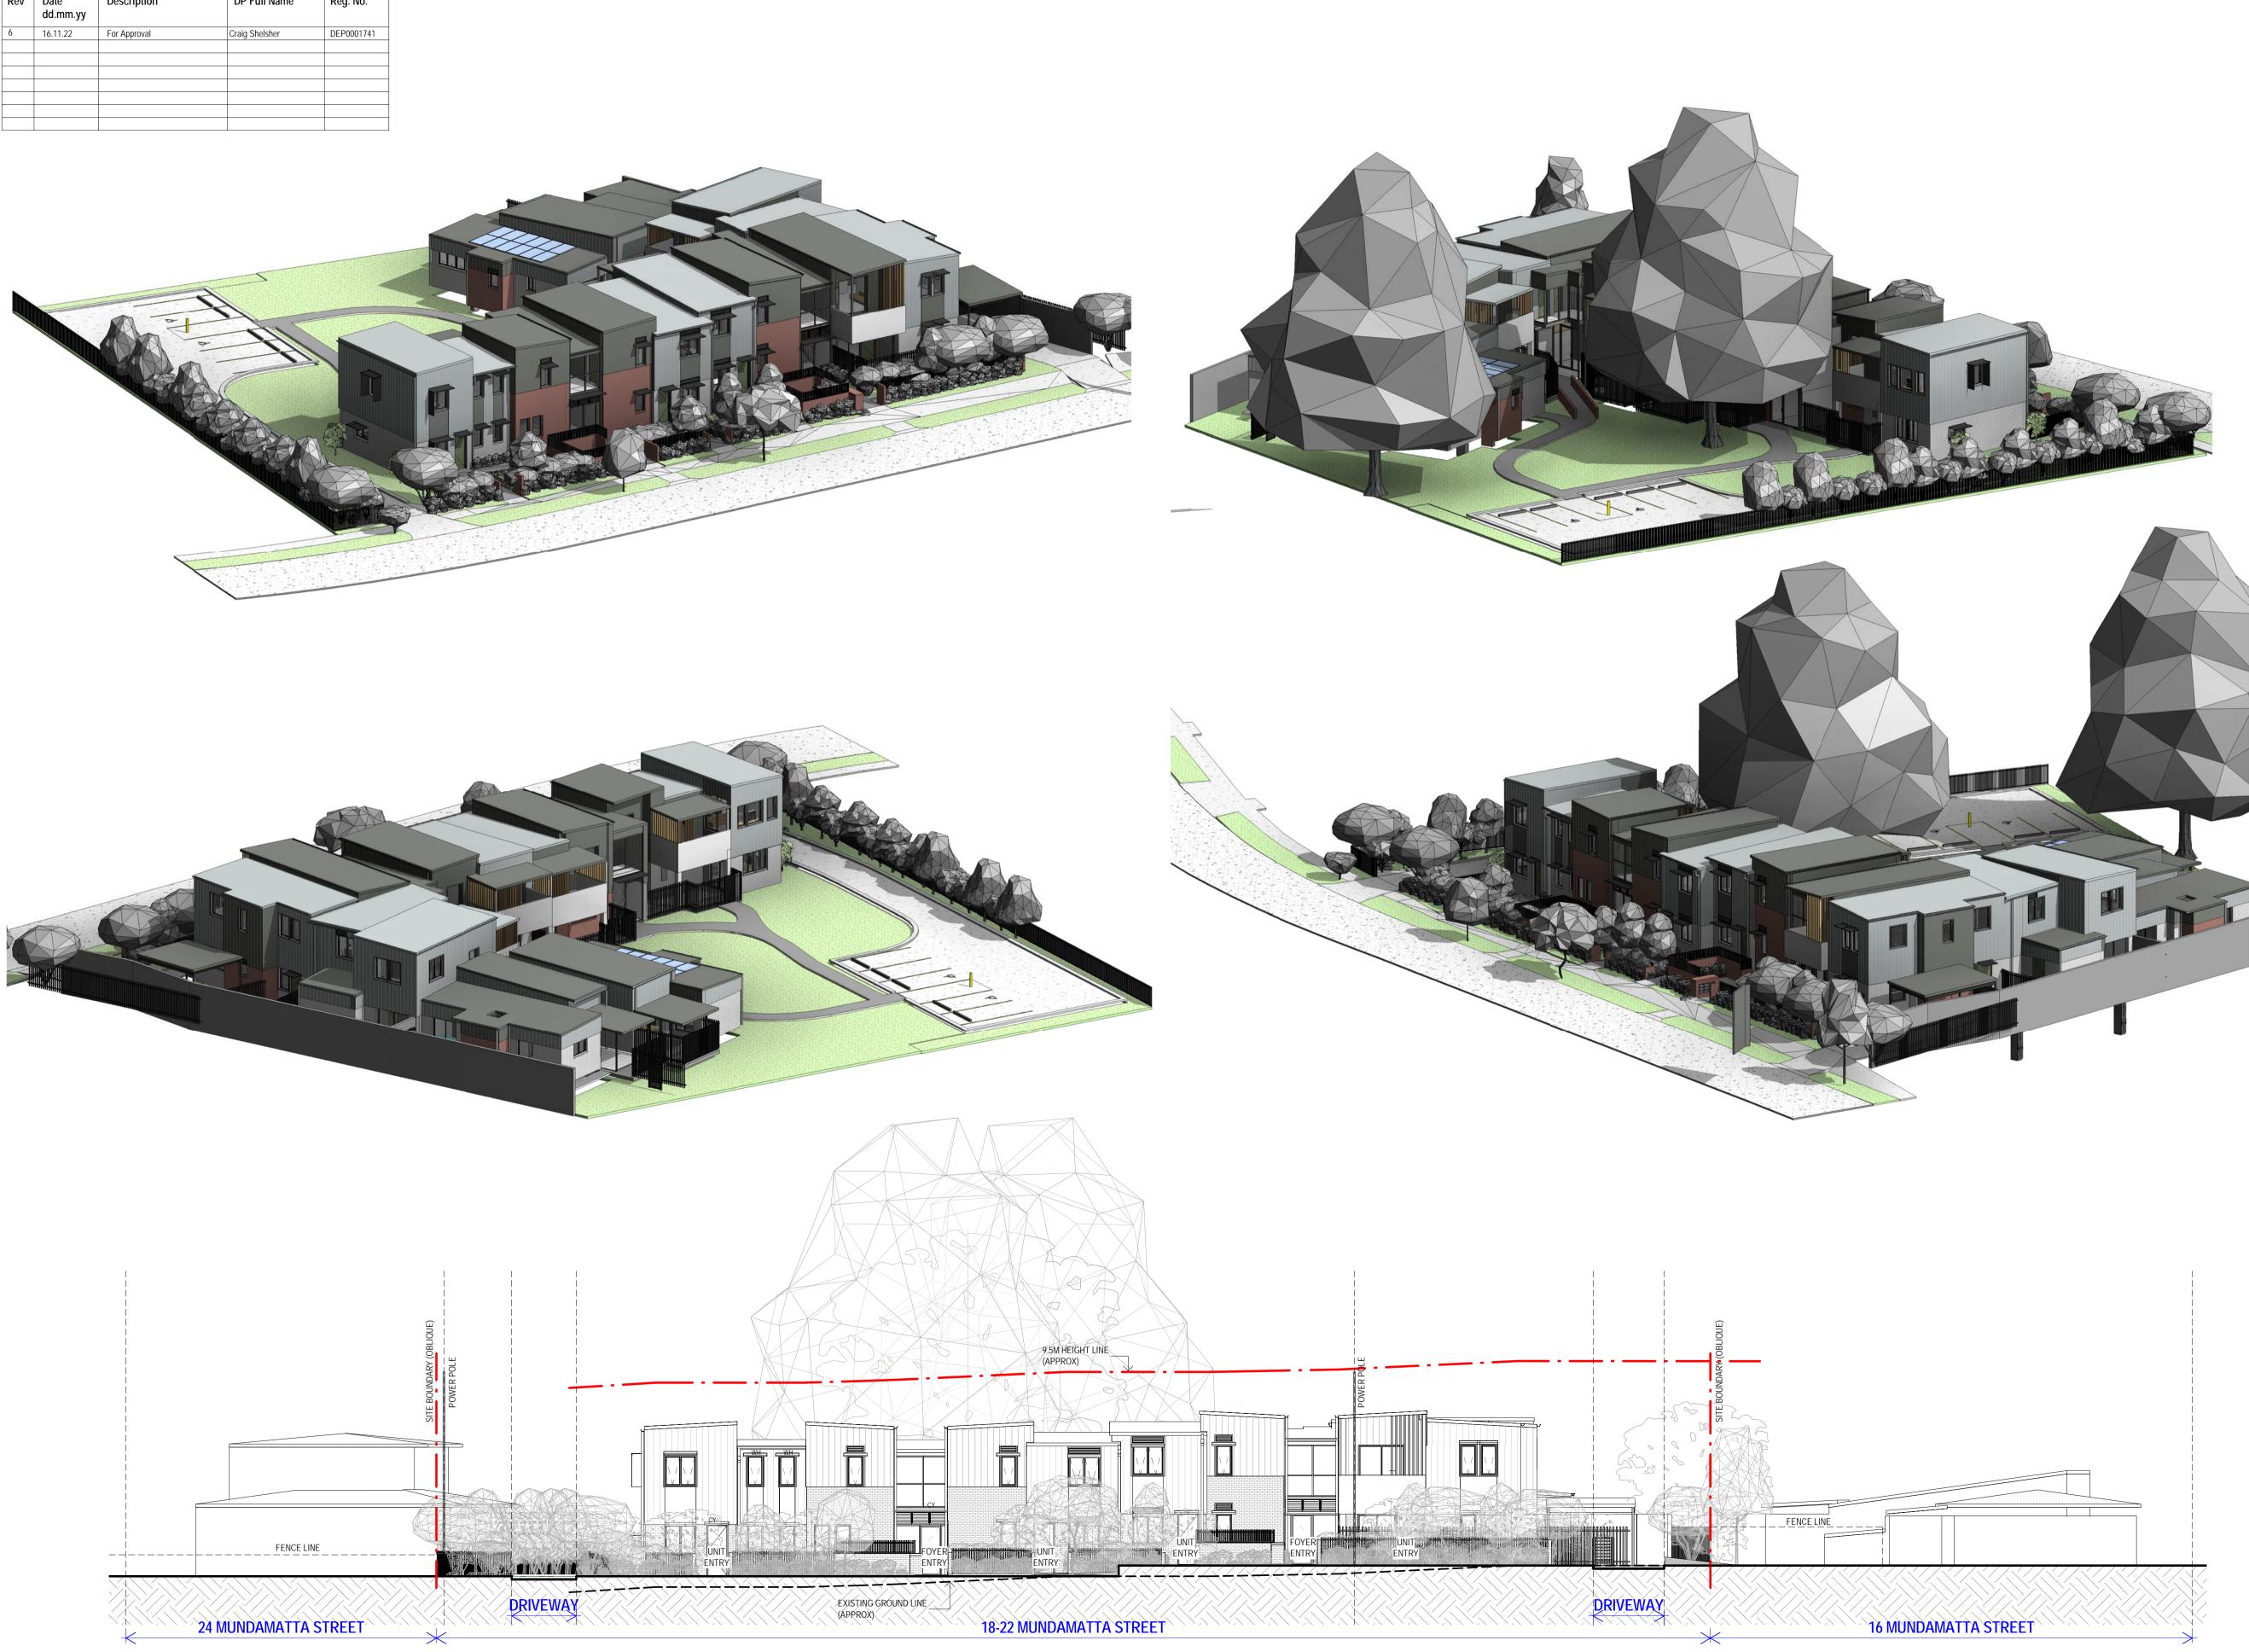
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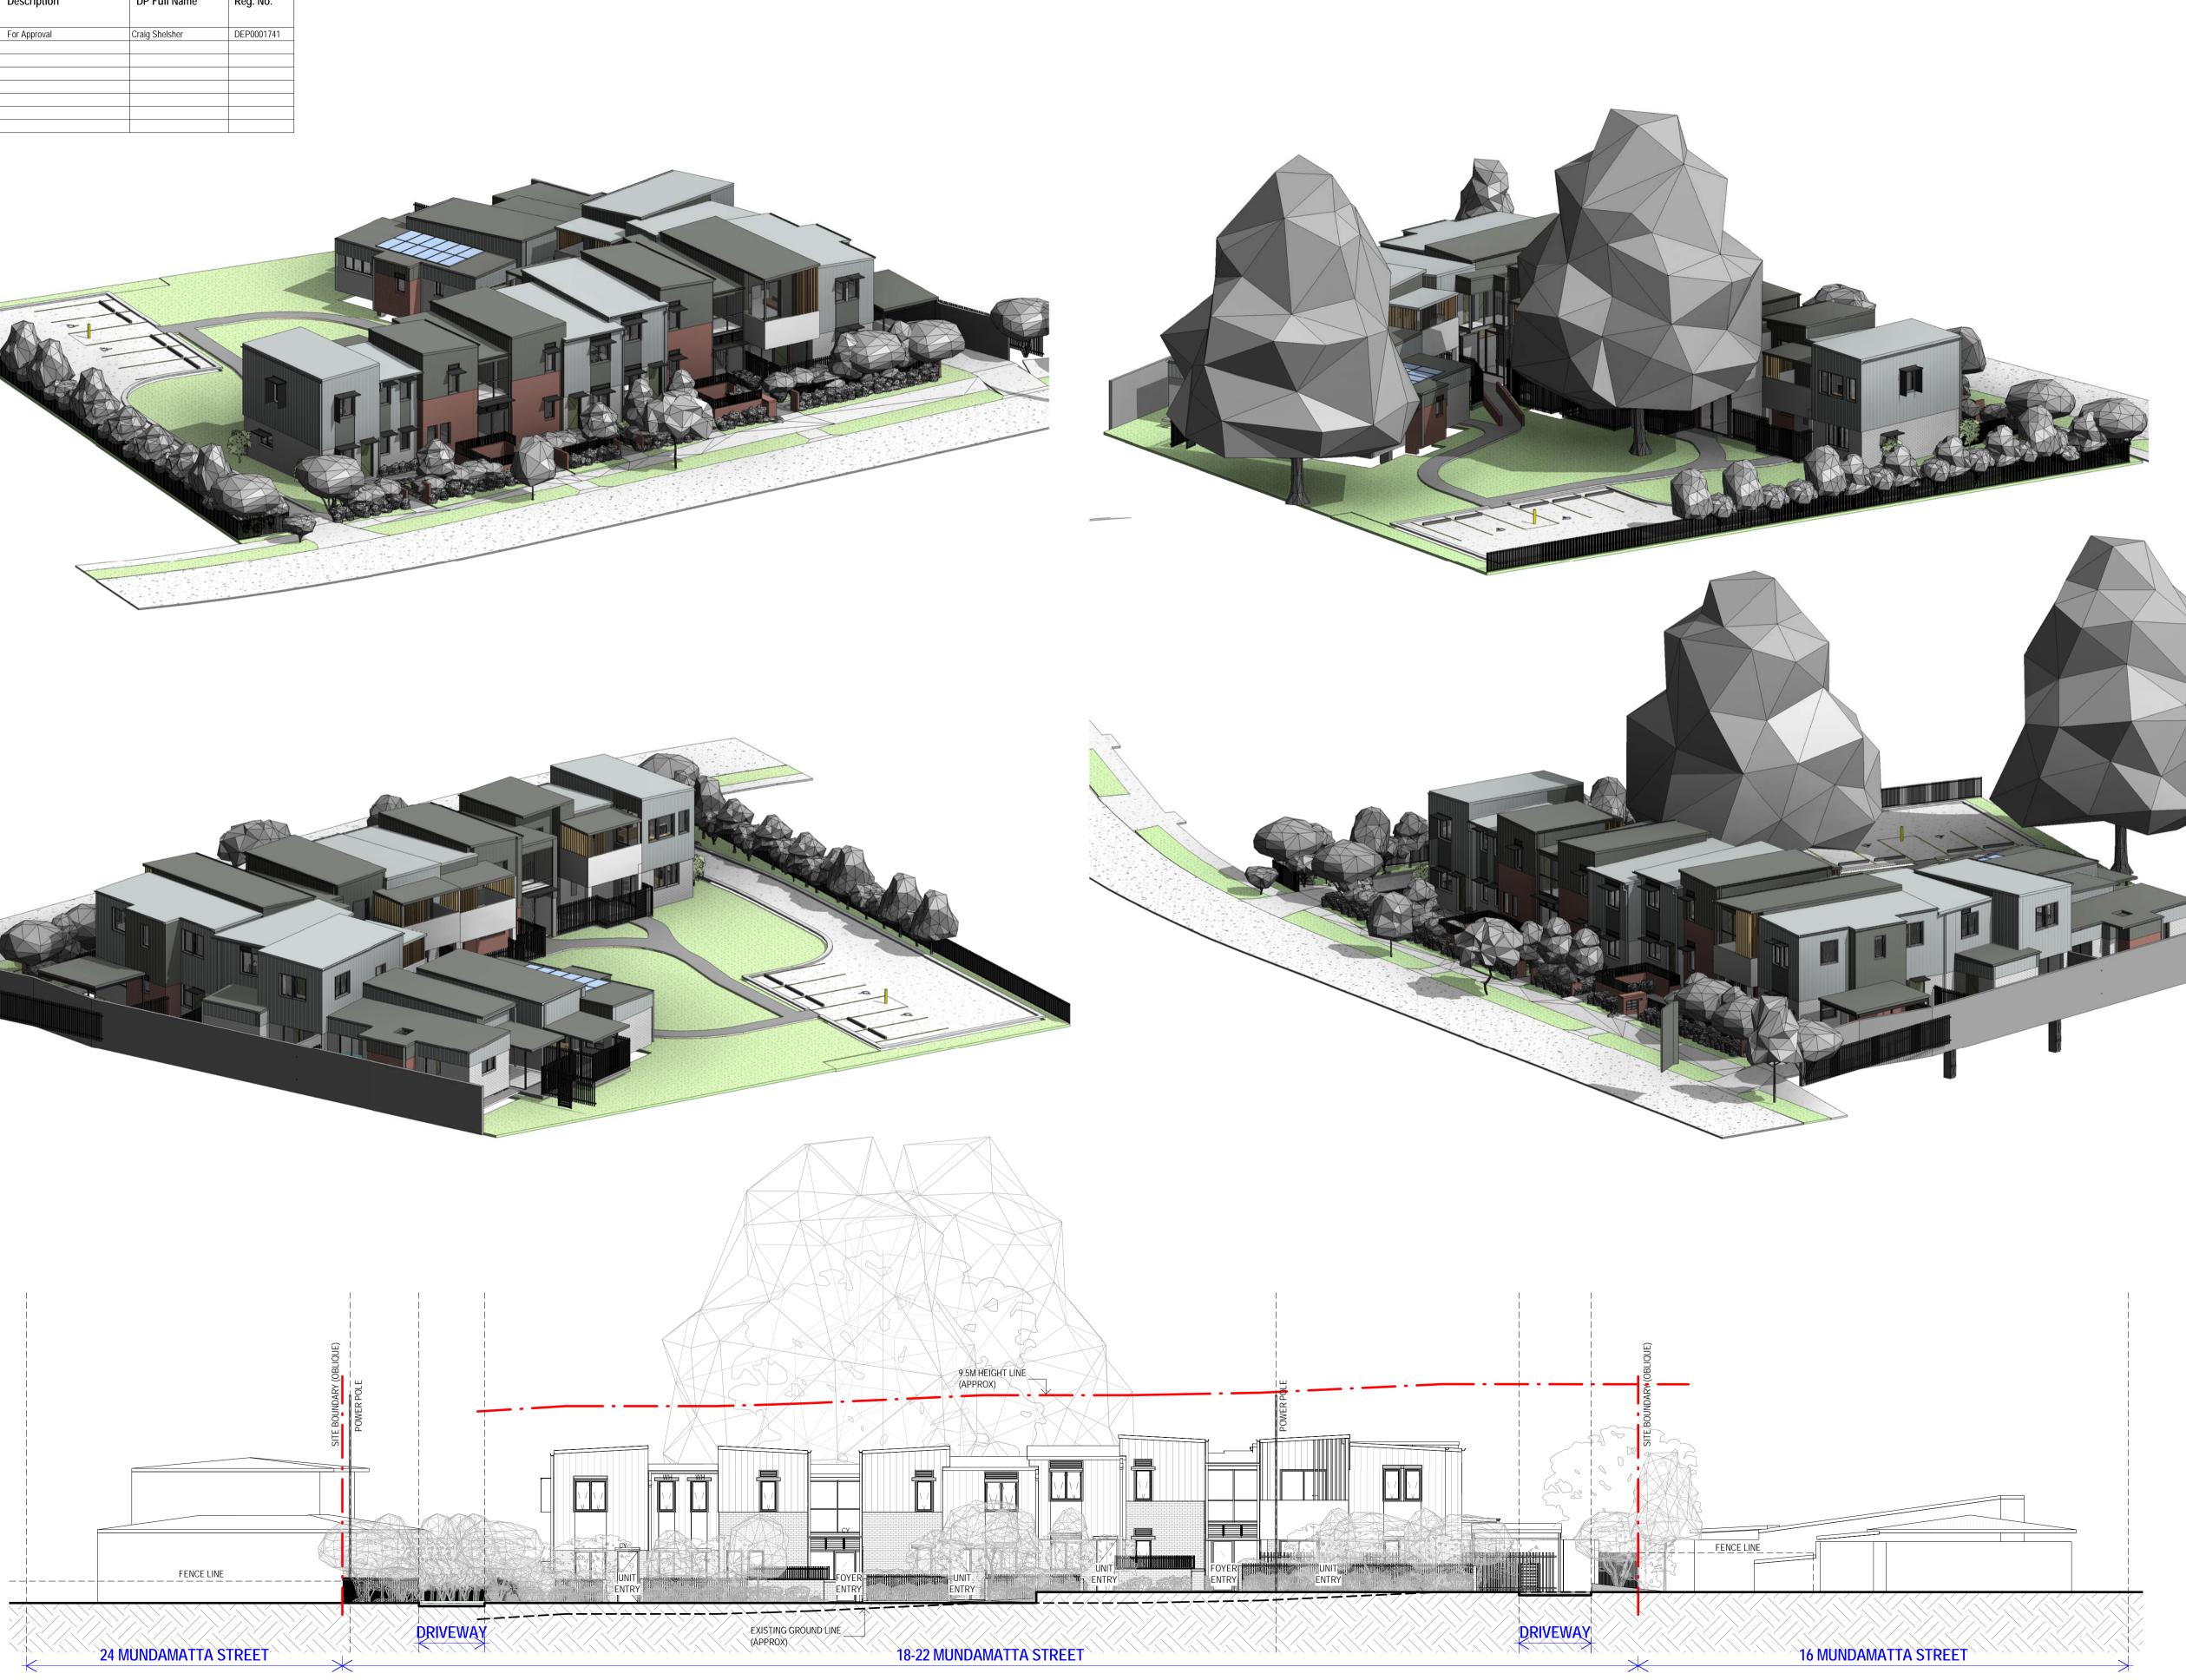
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Revision

7

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Project	Title: SENI	ORS HOUSING DEVELOP	PMENT, LAN	D AND HOUSING CORP	ORATION
Consent No: Body			Body Co	rporate Reg No:	
Drawing Title: 3D IMAGES Drawing No: DA		No: DA-6.00			
Rev	Date dd.mm.yy	Description	•	DP Full Name	Reg. No.
6	16.11.22	For Approval		Craig Shelsher	DEP0001741





STREETSCAPE ELEVATION - MUNDAMUTTA STREET

Revision Description

REVISION	Description	Dale
1	For Coordination	12/07/22
2	Progress Issue	28/07/22
3	Stage B Submission	05/08/22
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2. GRAPHIC PRESENTATION

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3. EXISTING STRUCTURES AND SERVICES


Extent and location of existing and proposed neighbouring structures and services is according to the available survey information and will need to be verified on site at later stage.


> THIS DRAWING IS TO BE PRINTED IN COLOUR

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Project 18-22 MUNDAMATTA STREET, VILLAWOOD NSW 2163 LOTS 814-816 SENIORS HOUSING DEVELOPMENT

Sheet Title

Project No.

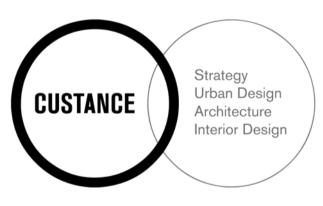3406

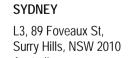3D IMAGES & STREETSCAPE ELEVATION

Scale Checked Drawr CS SC As indicated @ A1 It is intended that the drawings only represent the visual design of the work. Any technical details are for outline purposes only. The Contractor/ Manufacturer must separately provide all necessary shop tor oulline purposes only. The Contractor/ Manufacturer must separately provide all necessary shop drawings or calculations for compliance with any relevant industry, safety standards or Australian Standards, regulations or by-laws. Dimensions are to be checked on site, any discrepancies are to be referred to Custance Associates Pty Ltd, in writing, prior to proceeding. Use written dimensions only. Do not use scaled dimensions. Check for latest revision issue. ©Copyright of this drawing is vested with Custance Associates Pty Ltd Nominated Architect: Craig Shelsher 8259 (NSW), 5612 (QLD)

Sheet No.

DA-6.00

Revision

7

		Regulated	d Design Record		
Project	Address: 18-22	MUNDAMATTA STREET,	VILLAWOOD NSW 2163		
Project	Title: SENIO	ORS HOUSING DEVELOP	MENT, LAND AND HOUSING COR	PORATION	
Conser	nt No:		Body Corporate Reg No:		
Drawing Title: AREA CALCULATIONS			Drawing No: DA-11.00		
Rev	Date dd.mm.yy	Description	DP Full Name	Reg. No.	
6	16.11.22	For Approval	Craig Shelsher	DEP0001741	

UNIT AREA SCHEDULE		P.0	P.O.S AREA		
NO.	TYPE	AREA	TYPE	AREA	AREA TOTAL
UNIT 1	1BED	60.50 m ²	P.O.S	24.99 m ²	85.49 m ²
UNIT 2	1BED	59.52 m ²	P.O.S	24.57 m ²	84.08 m ²
UNIT 3	1BED	59.94 m ²	P.O.S	20.04 m ²	79.98 m ²
UNIT 4	2BED	70.59 m ²	P.O.S	43.08 m ²	113.67 m ²
UNIT 5	2BED	70.84 m ²	P.O.S	42.73 m ²	113.56 m ²
UNIT 6	2BED	71.19 m ²	P.O.S	76.18 m ²	147.36 m ²
UNIT 7	2BED	75.35 m ²	P.O.S	15.02 m ²	90.38 m ²
UNIT 8	1BED	61.12 m ²	BALCONY	11.26 m ²	72.38 m ²
UNIT 9	1BED	59.50 m ²	BALCONY	11.85 m ²	71.35 m ²
UNIT 10	1BED	59.94 m ²	BALCONY	11.14 m ²	71.07 m ²
UNIT 11	2BED	70.20 m ²	BALCONY	10.54 m ²	80.74 m ²
UNIT 12	1BED	59.18 m ²	BALCONY	11.09 m ²	70.28 m ²
Grand total		777.87 m ²		302.49 m ²	1080.36 m ²





1 FSR - GROUND FLOOR PLAN 1:250

SEPP GFA

SH GFA calculation (include stairs):

gross floor area means the sum of the areas of each floor of a building, where the area of each floor is taken to be the area within the inner face of the external enclosing walls, as measured at a height of 1.4m above each floor level—

(a) excluding columns, fin walls, sun control devices and elements, projections or works outside the general lines of the inner face of the external wall, and (b) excluding cooling towers, machinery and plant rooms, ancillary storage space and vertical air

conditioning ducts, and

(c) excluding—

(i) car parking needed to meet the requirements of this Part or the council of the local government area in which the development is located, and

(ii) internal access to the car parking, and

(d) excluding space for the loading and unloading of goods, including access to the space, and (e) for in-fill self-care housing—including car parking provided at ground level, other than for visitors,

in excess of 1 per dwelling, and (f) for a residential care facility—excluding floor space used for service activities provided by the facility below ground level (existing).







5 Level 1 A3.00 1:400

SEPP GFA AREA CALC.		
Level	Area	
Ground	530.21 m ²	
Level 1	370.79 m ²	
Grand total	901.00 m ²	

LEP GFA

LEP Std Instrument GFA definition e.g.:

gross floor area means the sum of the floor area of each floor of a building measured from the internal face of external walls, or from the internal face of walls separating the building from any other building, measured at a height of 1.4 metres above the floor, and includes—

(a) the area of a mezzanine, and (b) habitable rooms in a basement or an attic, and

(c) any shop, auditorium, cinema, and the like, in a basement or attic,

but excludes—

(d) any area for common vertical circulation, such as lifts and stairs, and

(e) any basement— (i) storage, and

(ii) vehicular access, loading areas, garbage and services, and

- (g) car parking to meet any requirements of the consent authority (including access to that car parking), and

(h) any space used for the loading or unloading of goods (including access to it), and (i) terraces and balconies with outer walls less than 1.4 metres high, and (j) voids above a floor at the level of a storey or storey above.



2 Ground A3.00 1:400



LEP GFA AREA		
Level		
Ground	478.90	
Level 1	316.25	
Grand total	795.16	



Revision	Description	Date
1	For Coordination	12/07/22
2	Progress Issue	28/07/22
3	Stage B Submission	05/08/22
4	For Approval	16/09/22
5	DA Issue	26/10/22
6	Part 5 Application	16/11/22
7	Stage 5 Approval- Addendum	17/11/22

(f) plant rooms, lift towers and other areas used exclusively for mechanical services or ducting, and



A CALC. Area 90 m² 25 m² 795.16 m²

NOTES : PART 5 APPLICATION

1. DESIGN RESOLUTION

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- further design development. The dimensions shown are general only and are subject to further design resolution.
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Project

18-22 MUNDAMATTA STREET, VILLAWOOD NSW 2163 LOTS 814-816 SENIORS HOUSING DEVELOPMENT

Sheet Title

AREA CALCULATIONS



SC

SCALE @ A1 1:100 2.5 0

Sheet No. Revision 7



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CS

vested with Custance Associates Pty Ltd Nominated Architect: Craig Shelsher 8259 (NSW), 5612 (QLD)



18-22 MUNDAMATTA STREET, VILLAWOOD NSW 2163 SENIORS LIVING DEVELOPMENT LAND AND HOUSING CORPORATION MECHANICAL SPATIAL ADVICE





DETERMINED by the NSW Land and Housing Corporation on: 24 August 2023

	Knox Advanced Engineering Pty Ltd (since 1999) W:knoxadv.com.au T: 02 8974 1433 M: 0420 465 854		
Consulting Engineers	Mechanical Electrical F	ire Hydrau	lics ESD Advice
PROJECT	18-22 MUNDAMATTA ST, VILLAWOOD NSW 2163		
DRAWING	MECHANICAL CONCEPT 1		
DRAWING No.	MSK_01 DATE: 23/06/202		23/06/2022
REV	1		
REVISIONS			

Revision	Description	Date
$\boldsymbol{\mathcal{C}}$		

PRELIMINARY
WORK-IN-PROGRESS

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KNOX ADVANCED ENGINEERING



Syaney W : (02) 8974 1433 M : ⊧61 0420 465 854 Web : www.knoxadv.com.au Email: jorgenk@knoxadv.com.

LAND AND HOUSING CORPORATION



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18-22 MUNDAMATTA STREET, VILLAWOOD NSW 2163 SENIORS LIVING DEVELOPMENT

Sheet Title


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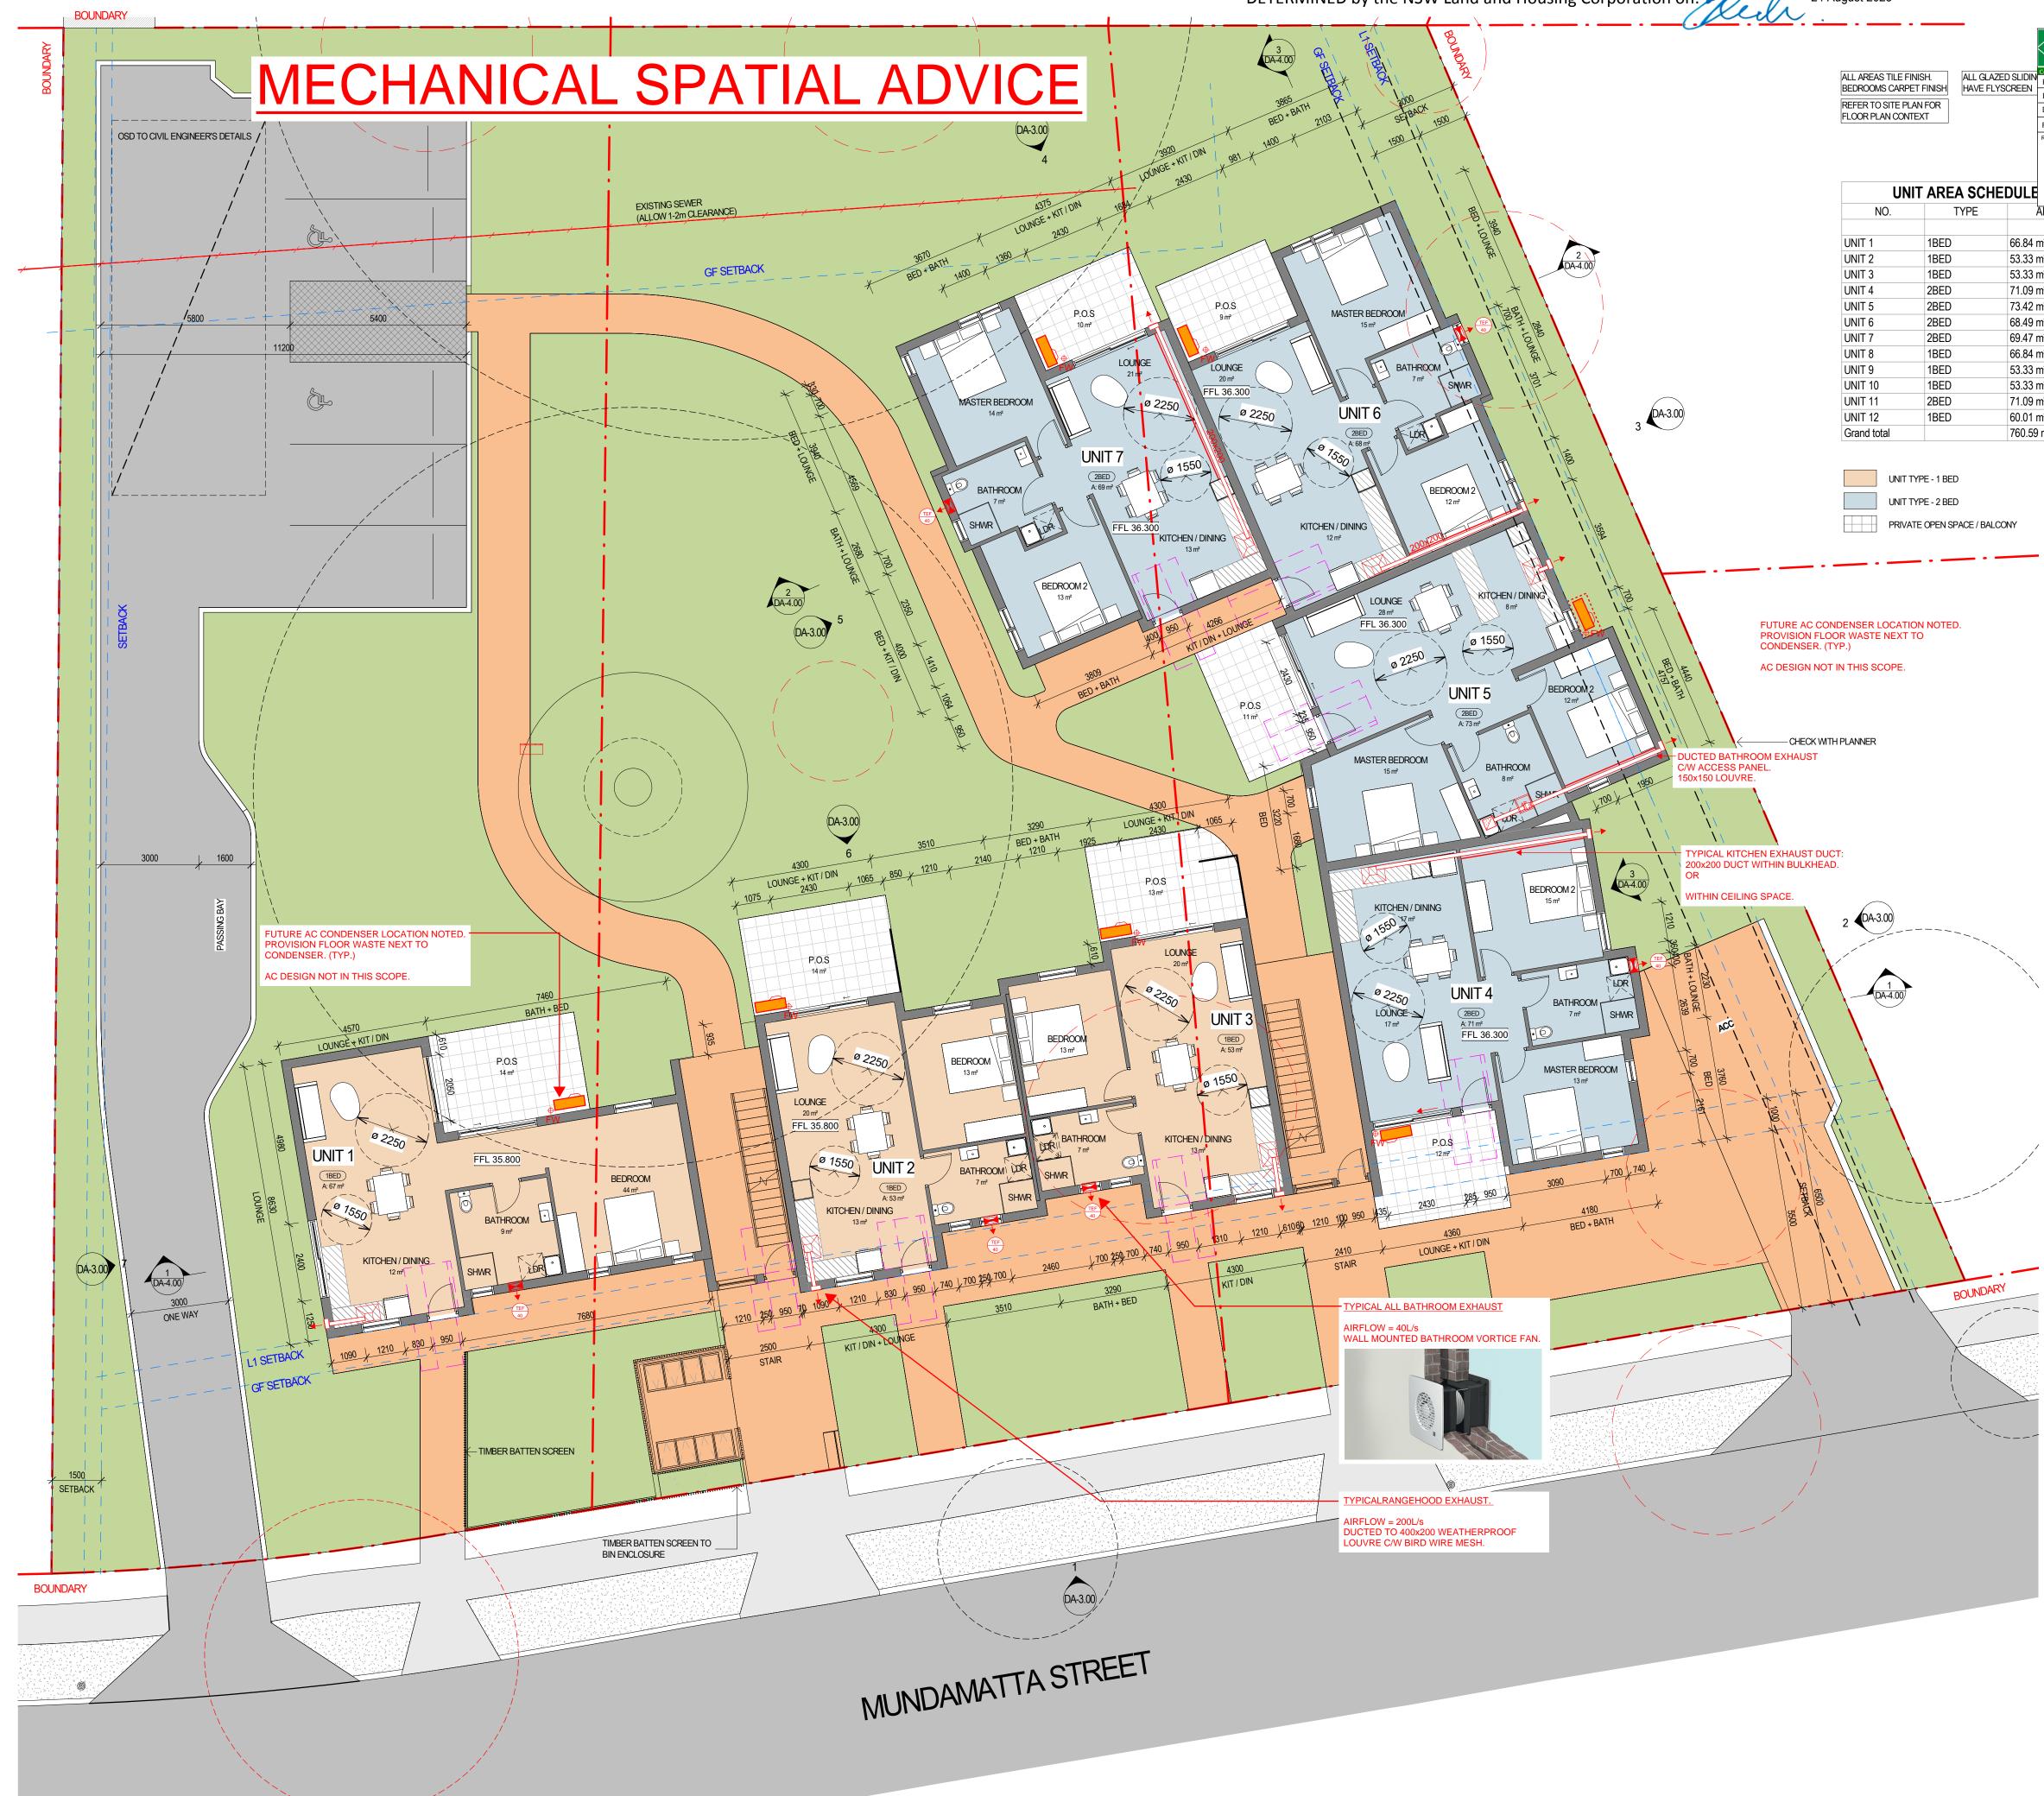
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Author	Checker	@ A1
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It is inte for outli drav Standards, regulations or by-laws. Dimensions are to be checked on site, any discrepancies are to be referred to Custance Associates Pty Ltd, in writing, prior to proceeding. Use written dimensions only. Do not use scaled dimensions. Check for latest revision issue. ©Copyright of this drawing is vested with Custance Associates Pty Ltd Nominated Architect: Craig Shelsher 8259 (NSW), 5612 (QLD)







6/17/2022 6:05:

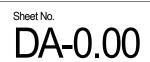DETERMINED by the NSW Land and Housing Corporation on: 24 August 2023

	Knox Advanced Engi (since 1999) W:knoxadv.com.au T: 02 8974 1433 M: 042	Ū	y Ltd
Consulting Engineers	Mechanical Electrical F	ire Hydrau	lics ESD Advice
PROJECT	18-22 MUNDAMATTA ST, VILLAWOOD NSW 2163		
DRAWING	MECHANICAL CONCEPT 1		
DRAWING No.	MSK_01 DATE: 23/06/2022		23/06/2022
REV	1		
REVISIONS			

AREA	TYPE	AREA
n²	P.O.S	13.61 m ²
n²	P.O.S	13.71 m ²
n²	P.O.S	13.10 m ²
n²	P.O.S	12.36 m ²
n²	P.O.S	11.04 m ²
n²	P.O.S	9.23 m ²
n²	P.O.S	9.55 m²
n²	BALCONY	10.90 m ²
n²	BALCONY	8.95 m ²
n²	BALCONY	8.94 m ²
n²	BALCONY	6.68 m ²
n²	BALCONY	0.00 m ²
m²		118.08 m ²

Revision	Description	Date



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Client

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LAND AND HOUSING CORPORATION



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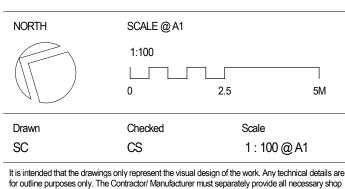
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18-22 MUNDAMATTA STREET, VILLAWOOD NSW 2163 SENIORS LIVING DEVELOPMENT

Sheet Title

Proiect

GA - GROUND




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Revision



BOUNDARY

DETERMINED by the NSW Land and Housing Corporation on:

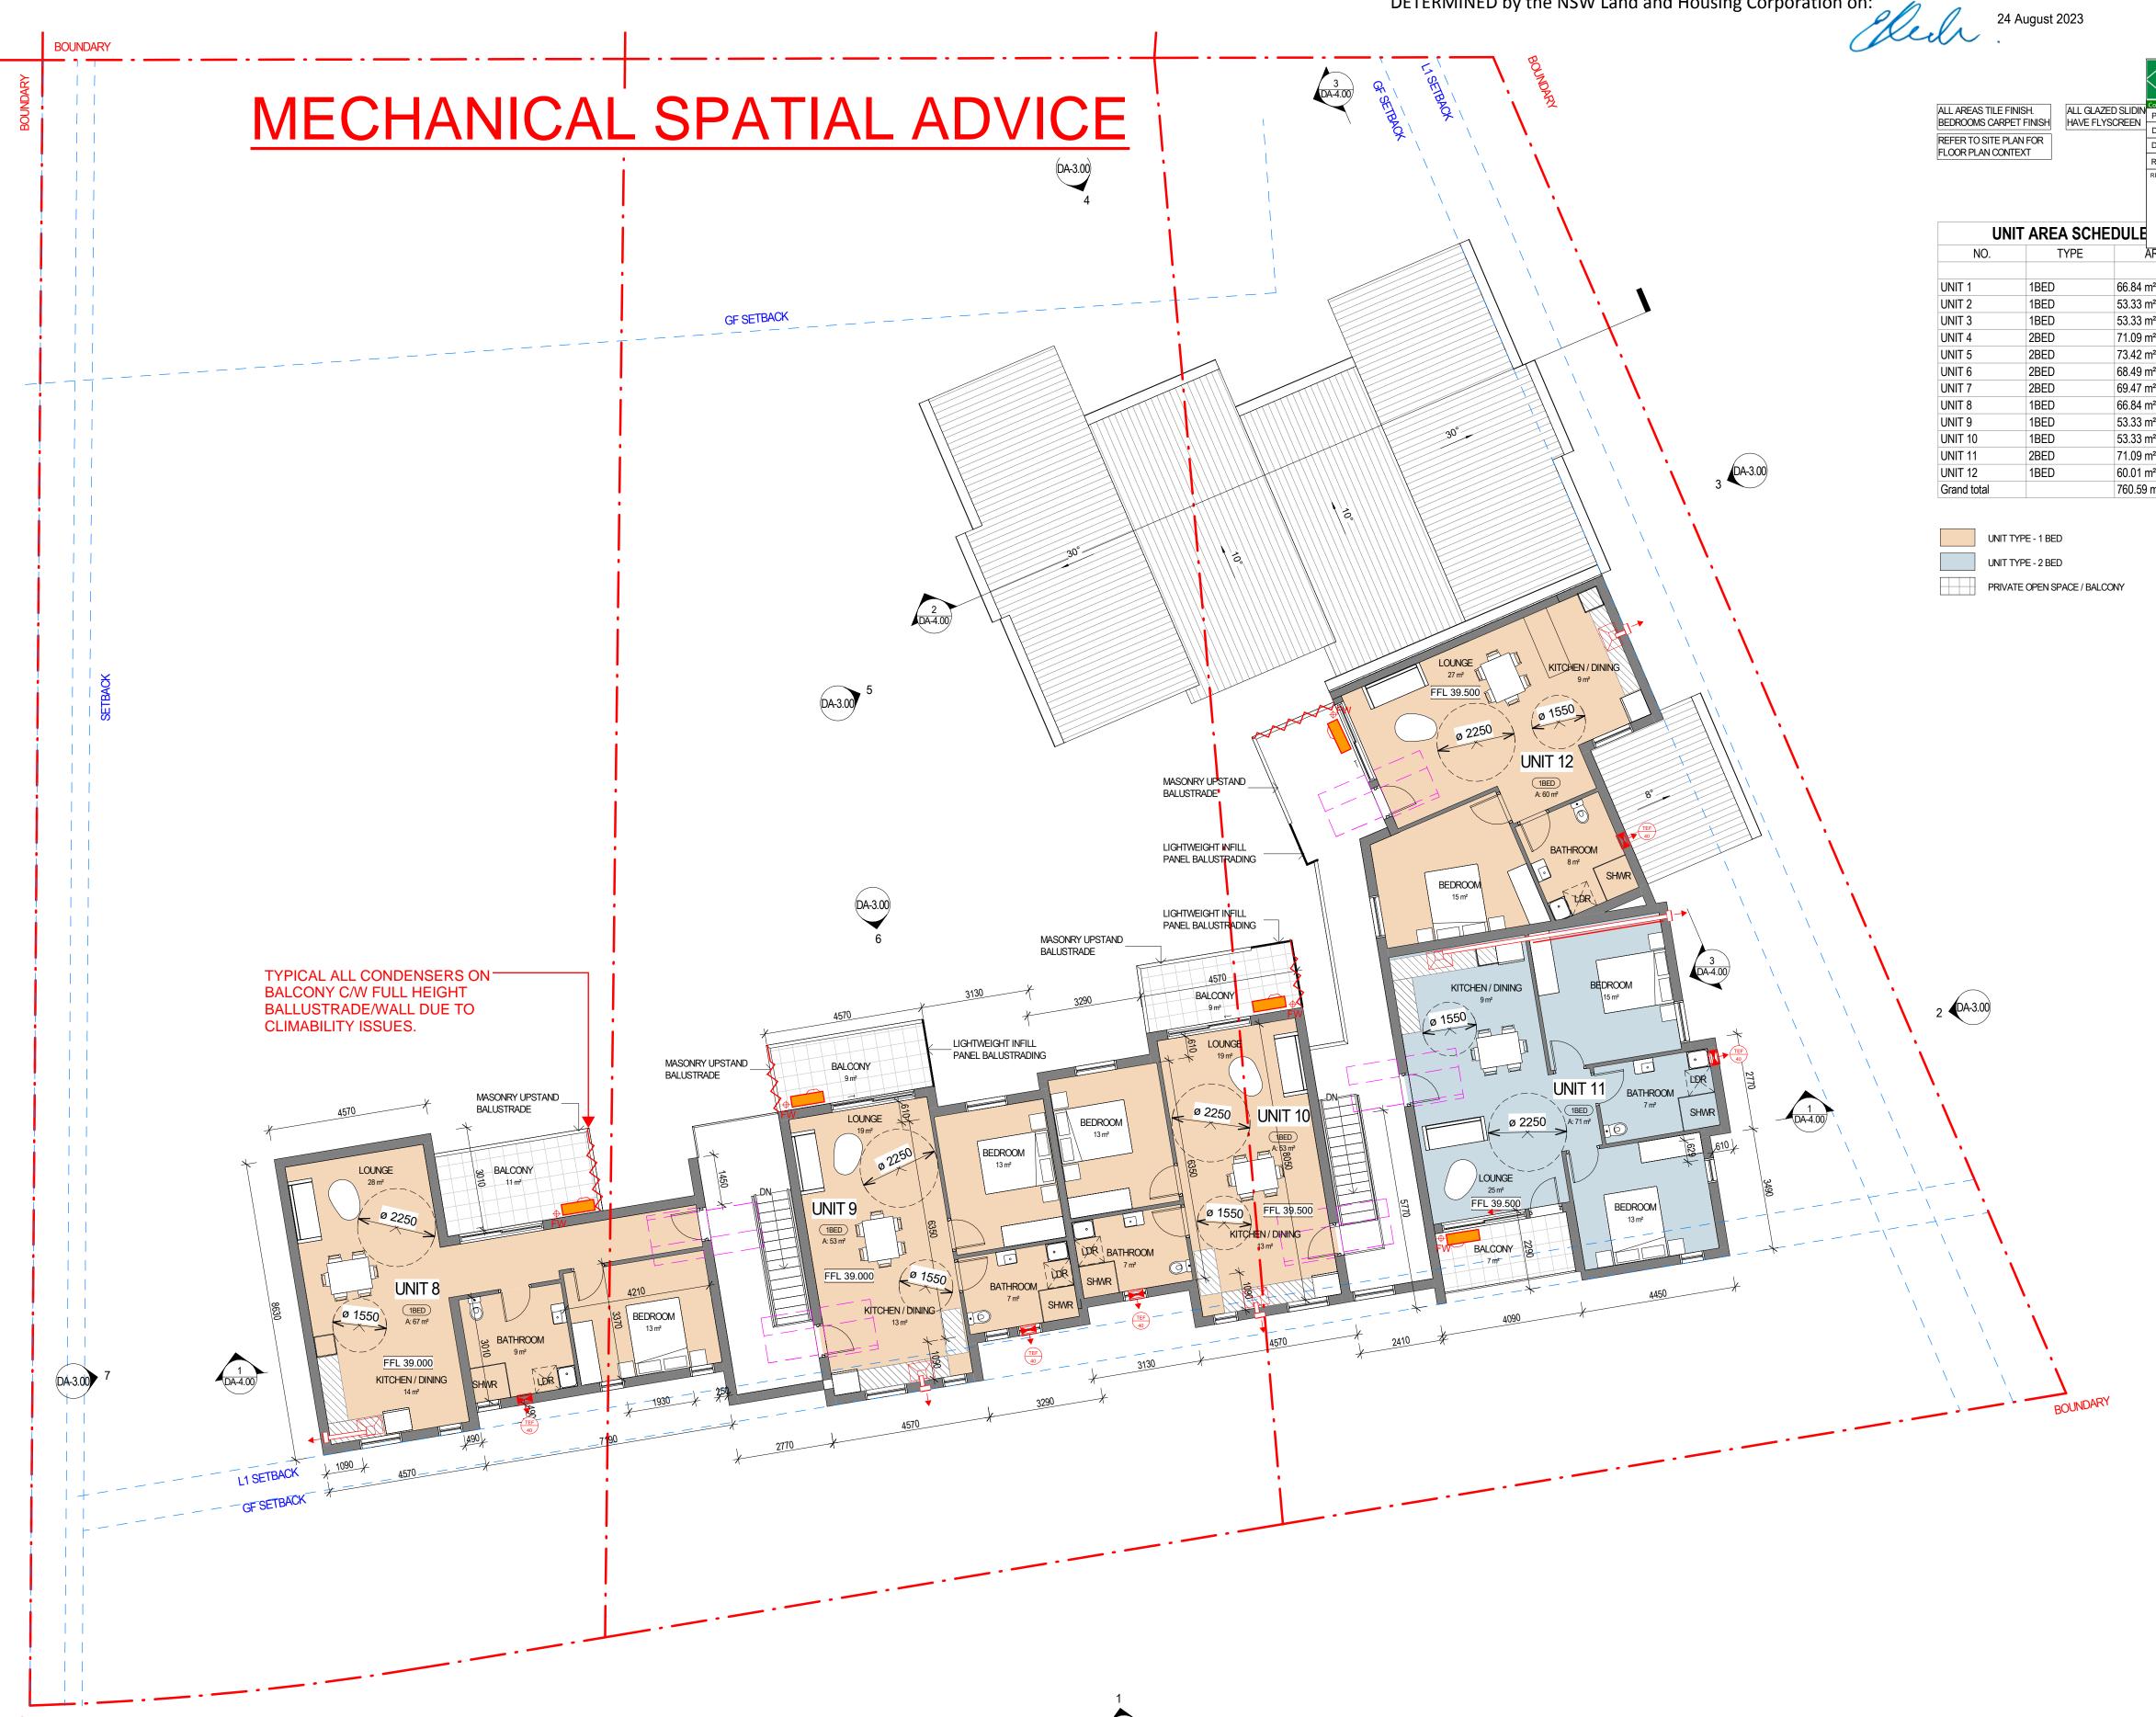DA-3.00

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Consulting Engineers	Mechanical Electrical F	ire Hydrau	lics ESD Advice
PROJECT	18-22 MUNDAMATTA ST, VILLAWOOD NSW 2163		
DRAWING	MECHANICAL CONCEPT 1		
DRAWING No.	MSK_01 DATE: 23/06/2022		23/06/2022
REV	1		
REVISIONS			

AREA	TYPE	AREA
n²	P.O.S	13.61 m ²
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Client LAND AND HOUSING CORPORATION



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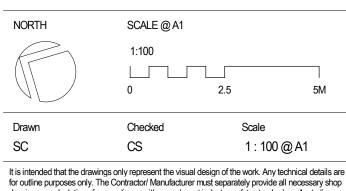
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18-22 MUNDAMATTA STREET, VILLAWOOD NSW 2163 SENIORS LIVING DEVELOPMENT

Sheet Title


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GA - LEVEL 1



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Revision



18-22 MUNDAMATTA STREET, VILLAWOOD Development Application Landscape Package

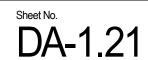








GROUND FLOOR LANDSCAPE PLAN

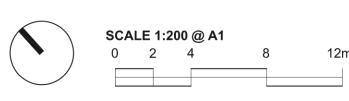



SITE BOUNDARY EXISTING TREE RETAINED



PROPOSED TREE

20.0 EXISTING CONTOUR 18.5 PROPOSED NEW CONTOUR × EX 18.25 EXISTING SPOT LEVEL +RL 20.0 PROPOSED SPOT LEVEL



DEEP SOIL CALCULATIONS

SITE AREA:

MINIMUM DEEP SOIL AREA REQUIREMENT 331.5m2 (15%) 583m2 (26.37%) PROPOSED DEEP SOIL AREA

MINIMUM LANDSCAPE AREA REQUIREMENT (Minimum 35 m2 per dwelling for 12 dwelling) PROPOSED LANDSCAPE AREA

LEGEND:

DEEP SOIL AREA (MINIMUM DIMENSION OF 3m)







PROPOSED GROUNDCOVERS CONCRETE UNIT PAVERS BY BORAL, 400mm SQUARE

project: client: date revision: drawn: DA checked: AL

18-22 MUNDAMATTA STREET, VILLAWOOD LAND AND HOUSING CORPORATION 25.11.2022

420 m2

950 m2




KEY PLAN

DESIGN NOTES:

- (01) EXISTING TREES TO BE RETAINED
- 02 FEATURE TREE TO FRONT COURTYARD
- (03) GRAVEL TRIM TO BUILDING
- 04 SCREEN PLANTING TO BOUNDARY
- 05 VEGETABLE GARDEN
- (06) SEATING WITH PERGOLAR
- 07 OPEN TURF FOR MULTIPLE ACTIVITY
- (08) ROOF STRUCTURE OVER CARPARK

2210.36m2 (100%)

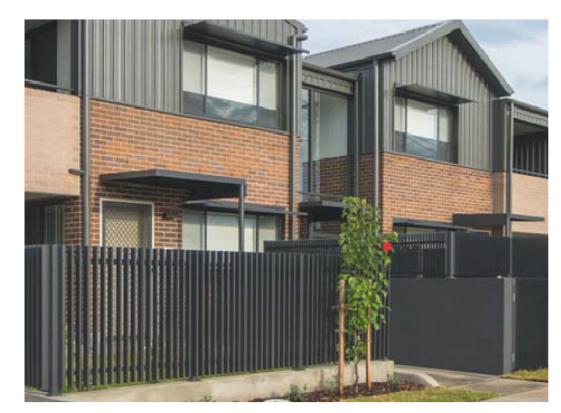


FENCE TO FRONTAGE

orBrammer la TAYLOR BRAMMER LANDSCAPE ARCHITECTS PTY LTD SYDNEY STUDIO 218 Oxford Street Woollahra, NSW, 2025 E sydney@taylorbrammer.com.au T 61 2 9387 8855 Copyright of Taylor Brammer Landscape Architects Pty Ltd. ABN 61 098 724 988





EXISTING TREE RETAINED AND REMOVED

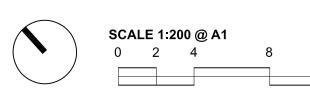



12m



R



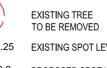

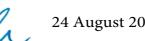

EXISTING VEGETATION SCHEDULE

ID	BOTANICAL NAME	COMMON NAME	HEIGHT (m)	SPREAD
Tree	retained			
Т8	Corymbia maculata	Spotted Gum	24m	18m
T11	Corymbia citriodora	Lemon Scented Gum	21m	20m
T13	Callistemon viminalis	Weeping Bottlebrush	6m	5m
T15	Tristaniopsis laurina	Water Gum	5m	4m
T16	Prunus sp.	Ornamental Cherry	4m	3m
T17	Prunus sp.	Ornamental Cherry	3m	2m
T18	Prunus sp.	Ornamental Cherry	3m	2m
T19	Prunus sp.	Ornamental Cherry	4m	3m
T20	Jacaranda mimosifolia	Jacaranda	8m	6m
	removed			
T1	Ligustrum lucidum	Ligustrum lucidum	4m	3m
Т2	Morus sp.	Mulberry	5m	4m
Т3	Callistemon sp.	Bottlebrush	6m	6m
Т4	Ligustrum lucidum	Large Leaf Privet	7m	6m
Т5	Group of weeds Passionfruit, Cestrur		3m	10m
Т6	Ligustrum lucidum	Ligustrum lucidum	5m	5m
Т7	Acacia sp.	Wattle	5m	4m
Т9	Cinnamomum camphora	Camphor Laurel	7m	7m
T10	Jacaranda mimosifolia	Jacaranda	9m	7m
T12	Callistemon viminalis	Weeping Bottlebrush	7m	6m
T14	Callistemon viminalis	Weeping Bottlebrush	6m	7m

ID	BOTANICAL NAME	COMMON NAME	HEIGHT (m)	SPREAD
Tree	<u>retained</u>			
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T11	Corymbia citriodora	Lemon Scented Gum	21m	20m
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T17	Prunus sp.	Ornamental Cherry	3m	2m
T18	Prunus sp.	Ornamental Cherry	3m	2m
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Tree	removed			
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Т5	Group of weeds Passionfruit, Cestrum, B	ouganvilea	3m	10m
Т6	Ligustrum lucidum	Ligustrum lucidum	5m	5m
Т7	Acacia sp.	Wattle	5m	4m
Т9	Cinnamomum camphora	Camphor Laurel	7m	7m
T10	Jacaranda mimosifolia	Jacaranda	9m	7m
T12	Callistemon viminalis	Weeping Bottlebrush	7m	6m
T14	Callistemon viminalis	Weeping Bottlebrush	6m	7m
NOTE:				
1	<i>Tree heights as per Arborist report prepar</i> Arterra	red by		




18-22 MUNDAMATTA STREET, VILLAWOOD project: client: LAND AND HOUSING CORPORATION 25.11.2022 date revision: drawn: checked: AL





TAYLOR BRAMMER LANDSCAPE ARCHITECTS PTY LTD SYDNEY STUDIO 218 Oxford Street Woollahra, NSW, 2025 E sydney@taylorbrammer.com.au T 61 2 9387 8855 ABN 61 098 724 988 Copyright of Taylor Brammer Landscape Architects Pty Ltd.

LANDSCAPE DETAILS

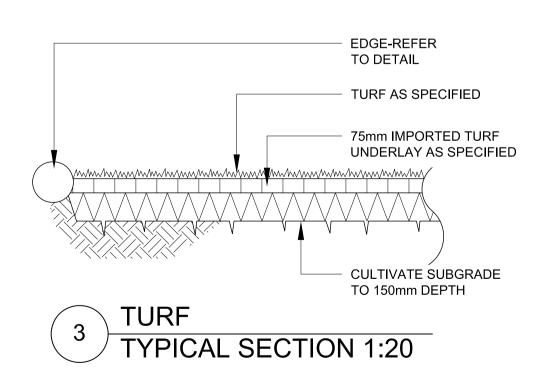




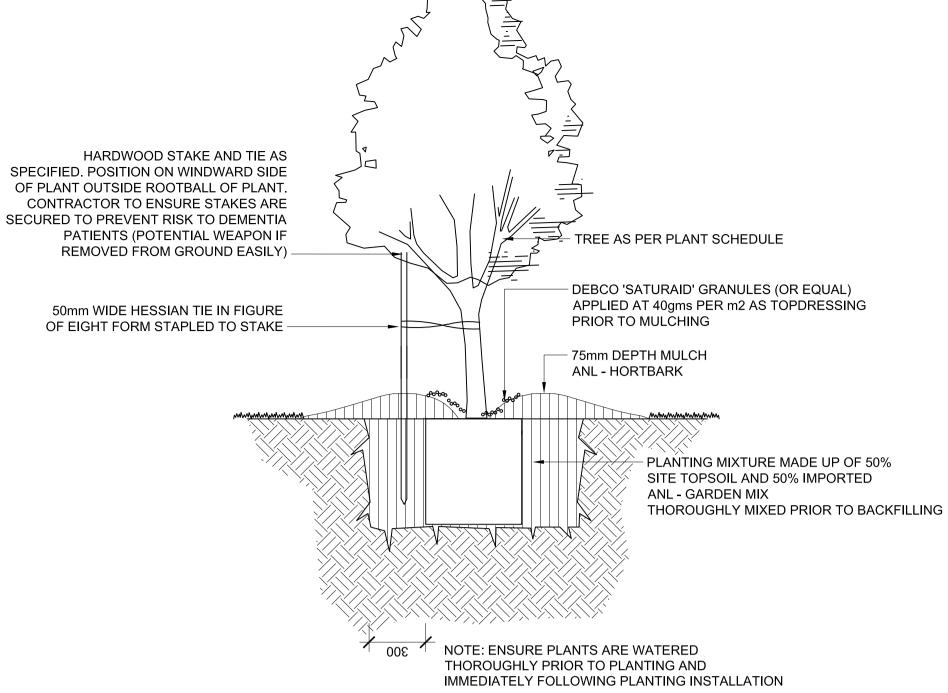


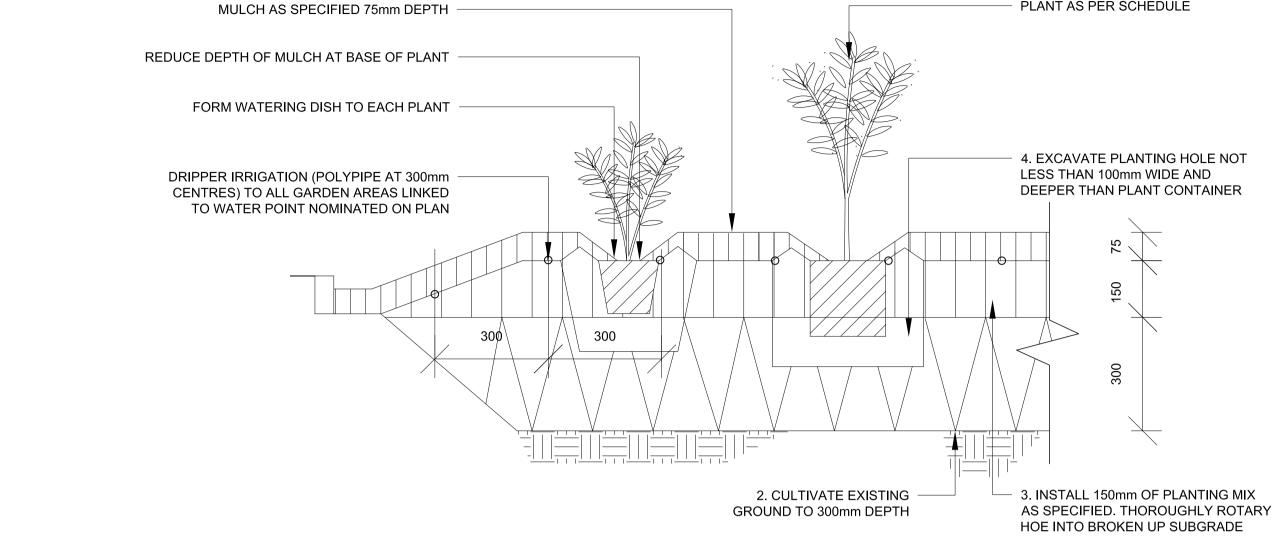



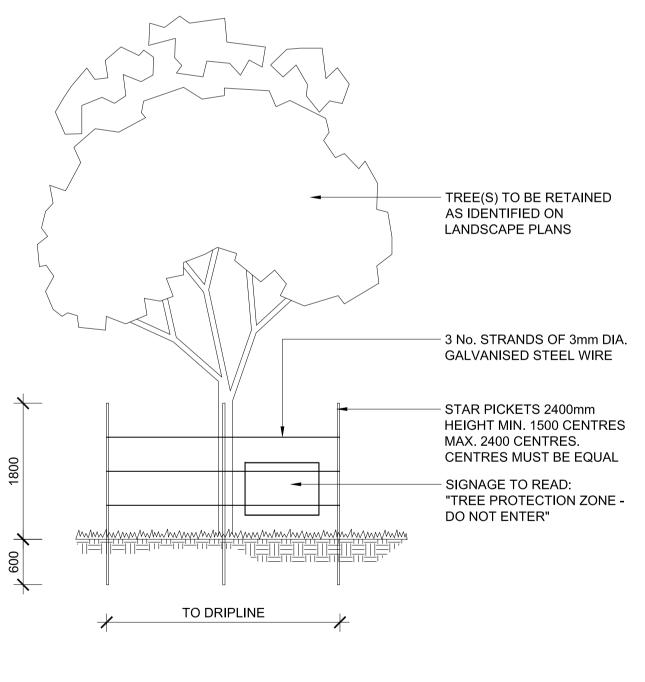



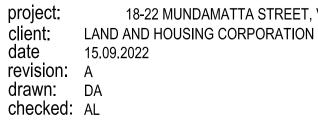

PLANT AS PER SCHEDULE

18-22 MUNDAMATTA STREET, VILLAWOOD







TAYLOR BRAMMER LANDSCAPE ARCHITECTS PTY LTD SYDNEY STUDIO 218 Oxford Street Woollahra, NSW, 2025 E sydney@taylorbrammer.com.au T 61 2 9387 8855 ABN 61 098 724 988 Copyright of Taylor Brammer Landscape Architects Pty Ltd.


LANDSCAPE DETAILS



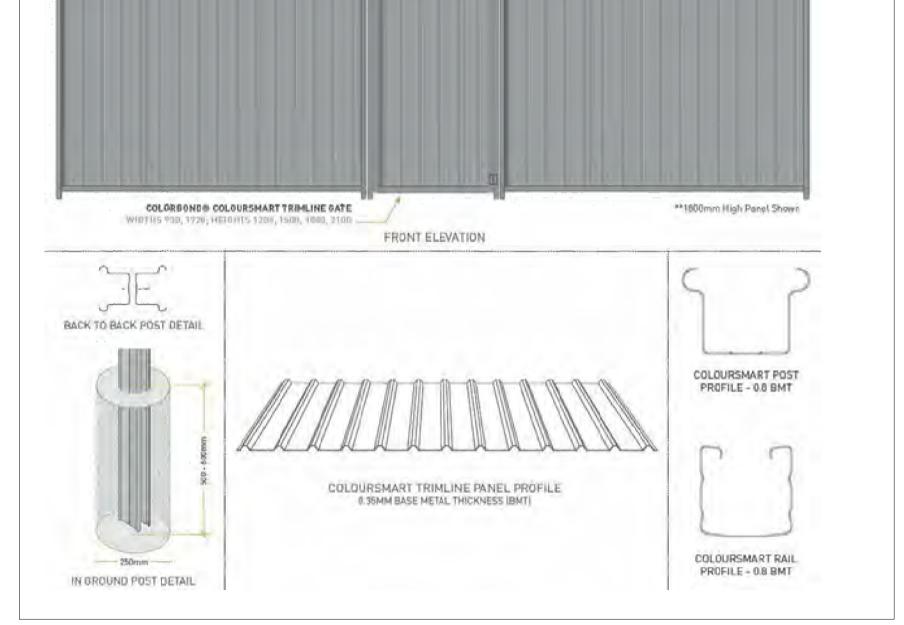


COLORBOND & COLOURSMART TRIMLINE PANEL WIDTHS 2600, 3100, HEIGHTS 1200, 1600, 1000, 2100

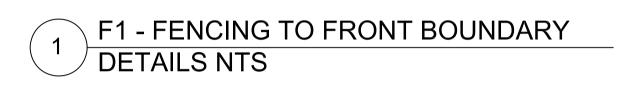

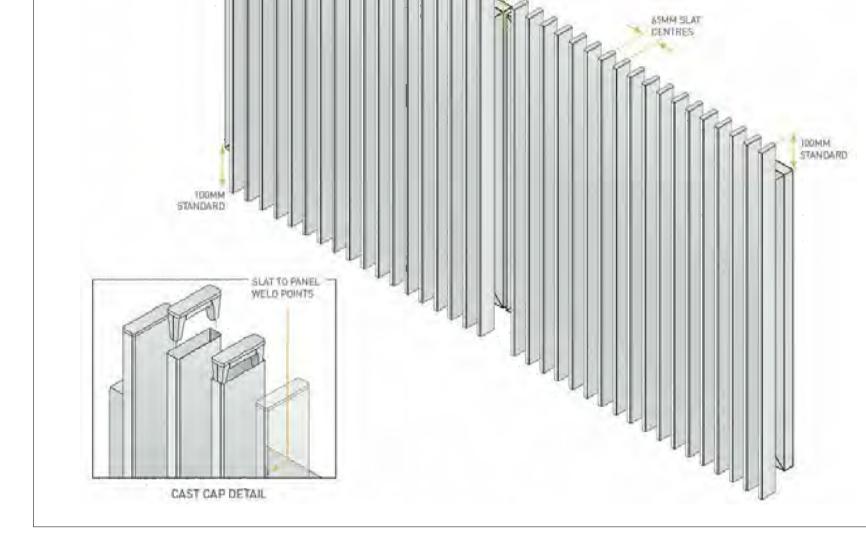


10-15MM PICAL OPENING

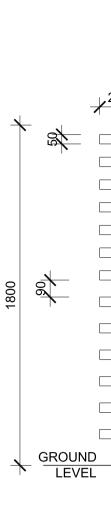

200	50 X 50mm SELECTED – HARD WOOD BATTENS	
$+\frac{200}{4}$		
-	1800	
	POST CENTRES	
SQUARE GALVANISED METAL POSTS. CONCRETE POST HOLE FOOTING		

F2 - FENCING TO PRIVATE PATIOS ELEVATION 1:20 2

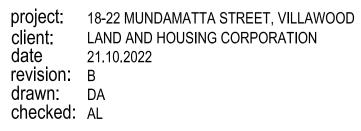

DETERMINED by the NSW Land and Housing Corporation on:



TAYLOR BRAMMER LANDSCAPE ARCHITECTS PTY LTD SYDNEY STUDIO 218 Oxford Street Woollahra, NSW, 2025 E sydney@taylorbrammer.com.au T 61 2 9387 8855 Copyright of Taylor Brammer Landscape Architects Pty Ltd. ABN 61 098 724 988

PROPOSED SENIORS LIVING DEVELOPMENT

18-22 Mundamatta Street, VILLAWOOD NSW 2163

STORMWATER SERVICES

}	STORMWATER PIPE
	STORMWATER RISING MAIN PIPE
E_____	EXISTING STORMWATER PIPE
	RAINWATER PIPE
	SUB-SOIL DRAINAGE LINE
	CAST IN SLAB PIPE

STORMWATER LEGEND

	PROPOSED SEALED JUNCTION PIT
	PROPOSED GRATED SUFACE INLET PIT. PIT DIMENSIONS ARE GOVERNED BY DEPTH REFER TO DETAIL.
	EXISTING PIT
	PIT TO BE REMOVED
	PROPOSED KERB INLET PIT
	PROPOSED GRATED DRAIN
0	PROPOSED RAINWATER TANK
0	Downpipe, riser or vertical drop rwo - rainwater outlet for balconies, roof, carpark etc
0	GS1 - DOWNPIPE WITH RAIN HEAD OVERFLOW
	GS2 - DOWNPIPE WITH SUMP

POSED KERB INLET PIT POSED GRATED DRAIN POSED RAINWATER TANK WNPIPE, RISER OR VERTICAL DROP O - RAINWATER OUTLET FOR CONIES, ROOF, CARPARK ETC - DOWNPIPE WITH RAIN AD OVERFLOW GS2 - DOWNPIPE WITH SUMP SIDE OVERFLOW GS3 - DOWNPIPE WITH SUME HIGH CAPACITY OVERFLOW SWALE DRAIN

OVERLAND FLOW PATH ROOF FALL DIRECTION PROPOSED PAVEMENT SURFACE LEVEL PROPOSED PIT SURFACE LEVEL PROPOSED PIT INVERT LEVEL PROPOSED FINISHED FLOOR LEVEL EXISTING SURFACE LEVEL

EXISTING SURVEY CONTOUR

GENERAL PIPEWORK LEGEND

SERVICE -	
SERVICE	

00

 $- \leftarrow \leftarrow \leftarrow \leftarrow$

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P 35.05

GL 35.05

IL 34.75

FFL 23.56

, 35.1

- 36.00

PIPE FROM ABOVE

FLOW DIRECTION

 \rightarrow Ś

- PIPE TO BELOW FALL DIRECTION STW Ø225 @ 1.0%min PIPE TYPE, SIZE AND GRADE CONNECTION CONTINUATION
 - END CAP **KEYNOTE TAG**

PROJECT INFORMATION TABLE THE TABLES BELOW ARE TO BE READ IN CONJUNCTION WITH THE ADJACENT NOTES

,	GEOTECHNICAL INFORMATION			
	COMPANY	REPORT No.	DATED	
	GEOTECHNICS PTY LTD	21/3539	01/12/2021	

SURVEY INFORMATION

THE SURVEY INFORMATION ON THESE DRAWING	S HAS BEEN PROVIDED I
COMPANY	DATED
NORTON SURVEY PARTNERS	04/12/2021

SAFETY IN DESIGN

THERE ARE INHERENT RISKS WITH CONSTRUCTING, MAINTAINING, OPERATING, DEMOLISHING, DISMANTLING AND DISPOSING THIS DESIGN THAT ARE TYPICAL OF SIMILAR DESIGNS. AS FAR AS IS REASONABLY PRACTICABLE RISKS HAVE BEEN ELIMINATED OR MINIMISED THROUGH THE DESIGN PROCESS HAZARD CONTROLS MUST STILL BE IMPLEMENTED BY THE CONTRACTOR, OWNER OR OPERATOR TO ENSURE THE SAFETY OF WORKERS.

• JN DO NOT CONSIDER THAT THERE ARE ANY UNIQUE RISKS ASSOCIATED WITH THE DESIGN OF THIS PROJECT

GENERAL

- 1. ALL EXISTING LEVELS TO BE CONFIRMED ON SITE PRIOR TO
- COMMENCEMENT OF WORKS 2. ALL WORKS SHALL BE CARRIED OUT IN ACCORDANCE WITH THE NOMINATED OR APPLICABLE COUNCIL SPECIFICATION. WHERE A SPECIFICATION HAS NOT BEEN NOMINATED THEN THE CURRENT NSW DEPARTMENT OF HOUSING CONSTRUCTION SPECIFICATION IS TO BE USED. THE NOMINATED SPECIFICATION SHALL TAKE PRECEDENCE TO THESE NOTES
- . THESE DRAWINGS ARE DIAGRAMMATIC AND SHOW THE GENERAL ARRANGEMENT. ALL DIMENSIONS SHOWN SHALL BE VERIFIED BY THE CONTRACTOR ON SITE. ENGINEERS DRAWINGS SHALL NOT BE SCALED FOR DIMENSIONS
- 4. ALL DRAWINGS SHOULD BE READ IN CONJUNCTION WITH THE RELEVANT ARCHITECTURAL DRAWINGS & DRAWINGS FROM OTHER CONSULTANTS
- 5. THE CONTRACTOR SHOULD REPORT ANY DISCREPANCIES ON THE DRAWINGS TO THE ENGINEER RESPONSIBLE FOR THE DESIGN
- 3. THE CONTRACTOR SHOULD LOCATE AND LEVEL ALL EXISTING SERVICES PRIOR TO COMMENCING CONSTRUCTION AND PROTECT AND MAKE ARRANGEMENTS WITH THE RELEVANT AUTHORITY TO RELOCATE AND/OR ADJUST IF NECESSARY. INFORMATION GIVEN ON THE DRAWINGS IN RESPECT TO SERVICES IS FOR GUIDANCE ONLY AND IS NOT GUARANTEED COMPLETE NOR CORRECT
- 7. CONTRACTOR IS NOT TO ENTER UPON NOR DO ANY WORK WITHIN ADJACENT LANDS WITHOUT THE PERMISSION OF THE OWNER.
- 8. SURPLUS EXCAVATED MATERIAL SHALL BE PLACED WHERE DIRECTED OR REMOVED FROM SITE.
- 9. ALL NEW WORKS SHALL MAKE A SMOOTH JUNCTION WITH EXISTING 10. ALL DRAINAGE LINES THROUGH ADJACENT LOTS SHALL BE CONTAINED WITHIN EASEMENTS CONFORMING TO COUNCIL'S
- STANDARDS 11. THE CONTRACTOR SHALL CLEAR THE SITE BY REMOVING ALL
- RUBBISH, FENCES AND DEBRIS FTC. TO THE EXTENT SPECIFIED. 12. PRIOR TO COMMENCEMENT OF WORK, THE CONTRACTOR SHALL PROVIDE A TRAFFIC MANAGEMENT PLAN PREPARED BY AN ACCREDITED PERSON IN ACCORDANCE WITH RMS REQUIREMENTS, FOR ANY WORK ON OR ADJACENT TO PUBLIC ROADS, PLAN TO BE SUBMITTED TO COUNCIL & RMS.

SURVEY

- 1. JONES NICHOLSON IS NOT RESPONSIBLE FOR THE ACCURACY OF ANY 3RD PARTY INFORMATION PROVIDED ON THIS DRAWING.
- 2. ALL LEVELS ARE TO A.H.D 3. ALL CHAINAGES AND LEVELS ARE IN METRES, AND DIMENSIONS IN
- MILLIMETRES. 4. SET OUT COORDINATES ARE BASED ON SURVEY DRAWINGS PROVIDED FOR THE PURPOSE OF CARRYING OUT THE
- ENGINEERING DESIGN 5. CONTRACTOR SHALL VERIFY ALL SET OUT COORDINATES SHOWN
- ON THE PLANS BY A REGISTERED SURVEYOR 6. CONTRACTORS SHALL ARRANGE FOR THE WORKS TO BE SET OUT
- BY A REGISTERED SURVEYOR 7. ANY DISCREPANCIES SHOULD BE CLARIFIED IN WRITING WITH THE ENGINEER PRIOR TO COMMENCEMENT OF THE WORK FOR CONFIRMATION OF THE SURVEY

EARTHWORKS

- 1. PROVIDE PROTECTION BARRIERS TO PROTECTED/SENSITIVE AREAS PRIOR TO ANY BULK EXCAVATION. 2. OVER FULL AREA OF EARTHWORKS, CLEAR VEGETATION, RUBBISH, SLABS ETC. AND STRIP TOP SOIL. AVERAGE 200mm THICK.
- REMOVE FROM SITE, EXCEPT TOP SOIL FOR RE-USE. CUT AND FILL OVER THE SITE TO LEVELS REQUIRE 4. PRIOR TO ANY FILLING IN AREAS OF CUT OR IN EXISTING
- GROUND, PROOF ROLL THE EXPOSED SURFACE. REFER TO PROJECT INFORMATION TABLES FOR MINIMUM ROLLER WEIGHT AND THE MINIMUM NUMBER OF PASSES. 5. EXCAVATE AND REMOVE ANY SOFT SPOTS ENCOUNTERED
- DURING PROOF ROLLING AND REPLACE WITH APPROVED FILL COMPACTED IN LAYERS. THE WHOLE OF THE EXPOSED SUBGRADE AND FILL SHALL BE COMPACTED TO 98% STANDARD MAXIMUM DRY DENSITY AT OPTIMUM MOISTURE CONTENT ± 2%.
- 6. FOR ON SITE FILLING AREAS, THE CONTRACTOR SHALL TAKE LEVELS OF EXISTING SURFACE AFTER STRIPPING TOPSOIL AND PRIOR TO COMMENCING FILL OPERATIONS.
- 7. WHERE HARD ROCK IS EXPOSED IN THE EXCAVATED SUB-GRADE, THIS WILL BE INSPECTED AND A DECISION MADE ON THE LEVEL TO WHICH EXCAVATION IS TAKEN. 8. FILL IN 200mm MAXIMUM (LOOSE THICKNESS) LAYERS TO
- UNDERSIDE OF BASECOURSE USING THE EXCAVATED MATERIAL AND COMPACTED TO 98% STANDARD (AS 1289 5.1.1). MAXIMUM DRY DENSITY AT OPTIMUM MOISTURE CONTENT ± 2% SHOULD THERE BE INSUFFICIENT MATERIAL FROM SITE EXCAVATIONS, IMPORT AS NECESSARY CLEAN GRANULAR FILL TO THE DESIGN ENGINEERS APPROVAL.
- 9. COMPACTION TESTING TO BE CARRIED OUT IN ACCORDANCE WITH THE PROJECT INFORMATION TABLE. THE COSTS OF TESTING AND RE-TESTING ARE TO BE ALLOWED FOR BY THE BUILDER. 10. BATTERS TO BE AS SHOWN, OR MAXIMUM 1 VERT : 4 HORIZ. ALL CONDUITS AND MAINS SHALL BE LAID PRIOR TO LAYING FINAL
- PAVEMENT 11. ALL BATTERS AND FOOTPATHS ADJACENT TO ROADS SHALL BE TOP Soiled with 150mm APPROVED LOAM AND SEEDED UNLESS OTHERWISE SPECIFIED.
- STORMWATER DRAINAGE INSTALLATION 1. SUPPLY & INSTALLATION OF DRAINAGE WORKS TO BE IN
- ACCORDANCEWITH THESE DRAWINGS, THE COUNCIL SPECIFICATION AND THE CURRENT APPLICABLE AUSTRALIAN standards.
- 2. BEDDING OF THE PIPELINES IS TO BE TYPE 'HS2' IN ACCORDANCE WITH THE STANDARDS AND AS FOLLOWS: a. COMPACTED GRANULAR MATERIAL IS TO COMPLY WITH THE FOLLOWING GRADINGS:

SIEVE SIZE (mm)	19	2.36	0.60	0.30	0.15	0.075
% MASS PASSING	100	50-100	20-90	10-60	0-25	0-10

- AND THE MATERIAL PASSING THE 0.075 SIEVE HAVING LOW PLASTICITY AS DESCRIBED IN APPENDIX D OF AS1726. b. BEDDING DEPTH UNDER THE PIPE TO BE 100mm. c. BEDDING MATERIAL TO BE EXTENDED FROM THE TOP OF THE BEDDING ZONE UP TO 0.3 TIMES PIPE OUTSIDE DIAMETER.

- THIS REPRESENTS THE 'HAUNCH ZONE.' d. THE BEDDING & HAUNCH ZONE MATERIAL IS TO BE COMPACTED TO A MINIMUM RELATIVE COMPACTION OF 98% WITHIN ROAD RESERVES AND TRAFFICABLE AREAS AND 95% ELSEWHERE FOR COHESIVE MATERIAL OR A MINIMUM
- DENSITY INDEX OF 70% IN ACCORDANCE WITH THE STANDARDS FOR COHESIONLESS MATERIAL. e. COMPACTION TESTING SHALL BE CARRIED OUT BY AN APPROVED ORGANISATION WITH A NATA CERTIFIED
- LABORATORY FOR ALL DRAINAGE LINES LAID WHOLLY OR IN PART UNDER THE KERB & GUTTER OR PAVEMENT. 3. BACKFILL SHALL BE PLACED & COMPACTED IN ACCORDANCE WITH THE SPECIFICATION. A GRANULAR GRAVEL AGGREGATE
- MATERIAL (<10mm) BACKFILL IS RECOMMENDED FOR THE BEDDING, HAUNCH SUPPORT AND SIDE ZONE DUE TO IT'S SELF COMPACTING ABILITY.
- 4. A MINIMUM OF 150mm CLEARANCE IS TO BE PROVIDED BETWEEN THE OUTSIDE OF THE PIPE BARREL AND THE TRENCH WALL FOR PIPES < 600 DIA. 200mm CLEARANCE FOR PIPES 600 TO 1200 DIA AND D/6 CLEARANCE FOR PIPES > 1200 DIA.

Job No. N0211373

STORMWATER DRAINAGE

- . STORMWATER DRAINAGE SHALL BE GENERALLY IN ACCORDANCE WITH CURRENT AUSTRALIAN STANDARDS AND COUNCIL'S SPECIFICATION.
- PIPES OF 225mm DIA. AND UNDER SHALL BE UPVC.
- PIPES OF 300mm DIA. AND LARGER SHALL BE FRC OR CONCRETE CLASS 2 RUBBER RING JOINTED UNO
- 4. ALL FRC OR RCP STORMWATER PIPES WITHIN ROAD RESERVE AREAS TO BE CLASS 3 U.N.O.
- MINIMUM COVER TO PIPES 300mm DIA. AND OVER GENERALLY SHALL BE 600mm IN CARPARK & ROADWAY AREAS UNO.
- . PIPES SHALL GENERALLY BE LAID AT THE GRADES INDICATED ON THE DRAWINGS

. PIPES UP TO 150mm DIA SHALL BE LAID AT 1.0% MIN. GRADE U.N.O. 8. PIPES 225mm DIA AND OVER SHALL BE LAID AT 0.5% MIN. GRADE

- 9. BACKFILL TRENCHES WITH APPROVED FILL COMPACTED IN 200mm LAYERS TO 98% OF STANDARD DENSITY. 10. ANY PIPES OVER 16% GRADE SHALL HAVE CONCRETE BULKHEADS AT
- ALL JOINTS. 11. PITS SHALL BE AS DETAILED WITH METAL GRATES AT LEVELS
- INDICATED. ALL PITS DEEPER THAN 1200mm TO HAVE CLIMB IRONS. 12. BUILD INTO UPSTREAM FACE OF ALL PITS A 3.0m SUBSOIL LINE
- FALLING TO PITS TO MATCH PIT INVERTS. 13. ALL COURTYARD & LANDSCAPED PITS TO BE 450 SQUARE LOAD
- CLASS A UNLESS NOTED OTHERWISE.
- 14. ALL DRIVEWAY & OSD PITS TO BE 600 SQUARE LOAD CLASS D UNLESS NOTED OTHERWISE. 15. INSTALL TEMPORARY SEDIMENT BARRIERS TO INLET PITS, TO COUNCIL'S STANDARDS UNTIL SURROUNDING AREAS ARE PAVED OR
- GRASSED 16. PITS & DOWNPIPE LOCATIONS AND LEVELS MAY BE VARIED TO SUIT SITE CONDITIONS AFTER CONSULTING THE ENGINEER. 17. DOWNPIPES SHOWN ARE INDICATIVE ONLY, ALL ROOF GUTTERING
- AND DOWNPIPES TO THE CURRENT AUSTRALIAN STANDARDS. 18. ALL PLANTER BOXES AND BALCONIES TO BE CONNECTED TO THE
- PROPOSED STORMWATER DRAINAGE LINE. 19. HAND-EXCAVATE STORMWATER PIPES IN VICINITY OF TREE ROOTS.
- 20. FOOTPATH CROSSING LEVELS SHOWN ARE TO BE ADJUSTED TO FINAL COUNCIL'S ISSUED LEVELS. 21. GEOTEXTILE FABRIC TO BE PLACED UNDER RIP RAP SCOUR
- PROTECTION. 22. ALL BASES OF PITS TO BE BENCHED TO HALF PIPE DEPTH AND
- PROVIDE GALVANISED ANGLE SURROUNDINGS TO GRATE.
- 23. SUBSOIL LINE PIPES AND FITTINGS SHALL BE PERFORATED PLASTIC TO CURRENT AUSTRALIAN STANDARDS, LAY PIPES ON FLOOR OF TRENCH GRADED AT 1% MIN. AND OVERLAY WITH FILTER MATERIAL EXTENDING TO WITHIN 200mm OF SURFACE. PROVIDE FILTER FABRIC OF PERMEABLE POLYPROPYLENE BETWEEN FILTER MATERIAL AND
- TOPSOIL 24. SHOULD THE CONTRACTOR ELECT TO INSTALL PRECAST STORMWATER PITS AND THEY ARE PERMITTED BY COUNCIL AND THE CLIENT, THE PRECAST PITS ARE TO BE CONSTRUCTED IN
- ACCORDANCE WITH RMS STANDARDS INCLUDING: 1. SEAL THE SEGMENTS TOGETHER USING A SITE-APPROVED NON-SHRINK GROUT OR MASTIC-TYPE PRODUCT. APPLY THE SEALANT
- IN ACCORDANCE WITH THE PRODUCT MANUFACTURER'S REQUIREMENTS 2. ENSURE THAT NO GAPS REMAIN AND THAT A SMOOTH FACE
- EXISTS BETWEEN MULTIPLE UNITS.
- LEAVE THE SEGMENTS UNDISTURBED UNTIL THE PERIOD OF CURING IS COMPLETED IN ACCORDANCE WITH THE GROUT OR SEALANT PRODUCT MANUFACTURER'S REQUIREMENTS.

PAVEMENT LEGEND

	EXTENT OF CONCRETE PAVEMENT	6
DJ	DOWELLED JOINT	7
KJ	KEYED JOINT	
<u>SC</u>	SAW CUT JOINT	8
BJ	BUTT JOINT	9
	2N12 TRIMMERS x 1200 LONG (TIED UNDER TOP MESH)	
150 K&G	150mm HIGH KERB & GUTTER	ł
150 KO	150mm HIGH KERB ONLY	1
	EXTENT OF BITUMEN PAVEMENT	
	PAVEMENT TYPE 1 - CONCRETE	2
	PAVEMENT TYPE 2 - BITUMEN	3
	PAVEMENT TYPE 3 - CONCRETE FOOTPATH	4
	PAVEMENT TYPE 4 - GRAVEL	5
	PAVEMENT TYPE 5 - PAVERS	E
	LANDSCAPE PLANTING AREA	7
	LANDSCAPE TILED AREA	8
	LANDSCAPE WATER AREA	

FALL

FALL DIRECTION

PAVEMENT - RIGID

- 1. THE PAVEMENT DESIGN AS DETAILED ASSUMES A PROPERLY PREPARED UNIFORM AND STABLE SUBGRADE. CONFIRMATION OF DESIGN CBR RATIO IS REQUIRED BY A GEOTECHNICAL ENGINEER PRIOR TO WORKS COMMENCING
- 2. PREPARATION FOR PAVEMENT: CLEAR SITE, STRIP TOPSOIL, CUT AND FILL AND PREPARATION OF SUBGRADE SHALL BE AS DESCRIBED IN "EARTHWORKS" NOTES
- 3. SUBGRADE SHALL BE COMPACTED TO 98% STANDARD MAXIMUM DRY DENSITY AT OPTIMUM MOISTURE CONTENT ± 2% IN ACCORDANCE WITH AS 1289.5.1.1
- 4. BASE COURSE SHALL BE CONSTRUCTED FROM FINE CRUSHED ROCK DGB20 COMPACTED TO 100% STANDARD MAXIMUM DRY DENSITY AT OPTIMUM MOISTURE CONTENT ± 2% IN ACCORDANCE WITH AS 1289 5.1.11
- 5. CONCRETE PAVEMENT SLABS SHALL BE AS DETAILED ON THE DRAWINGS 6. ALL WORKMANSHIP AND MATERIALS FOR CONCRETE WORK SHALL BE IN ACCORDANCE WITH AS 3600 AND AS 3610 CURRENT EDITIONS WITH AMENDMENTS, EXCEPT WHERE VARIED BY THE CONTRACT DOCUMENTS.
- 7. CONCRETE QUALITY ALL CEMENT SHALL BE TYPE SL SHRINKAGE LIMITED CEMENT IN ACCORDANCE WITH AS3972

ELEMENT	STRENGTH GRADE (MPa)	SLUMP	MAXIMUM AGGREG. SIZE (mm)
PAVEMENT	32	80	20

- 8. PROJECT CONTROL TESTING SHALL BE CARRIED OUT IN ACCORDANCE WITH AS 3600.
- 9. NO ADMIXTURES SHALL BE USED IN CONCRETE UNLESS APPROVED IN WRITING.
- 10. CLEAR CONCRETE COVER TO ALL REINFORCEMENT FOR DURABILITY SHALL
- BF 40mm. 11. CONSTRUCTION JOINTS WHERE NOT SHOWN SHALL BE LOCATED TO THE
- APPROVAL OF THE ENGINEER. 12. THE FINISHED CONCRETE SHALL BE MECHANICALLY VIBRATED TO ACHIEVE A DENSE HOMOGENEOUS MASS. COMPLETELY FILLING THE FORMWORK THOROUGHLY EMBEDDING THE REINFORCEMENT AND FREE OF STONE POCKETS. CONCRETE SHALL BE COMPACTED WITH MECHANICAL VIBRATORS
- 13. CURING OF ALL CONCRETE IS TO BE ACHIEVED BY KEEPING SURFACES CONTINUOUSLY WET FOR A PERIOD OF THREE DAYS, AND THE PREVENTION OF LOSS OF MOISTURE FOR A TOTAL OF 7 DAYS FOLLOWED BY A GRADUAL DRYING OUT
- 14. REPAIRS TO CONCRETE SHALL NOT BE ATTEMPTED WITHOUT THE PERMISSION OF THE ENGINEER
- PAVEMENT FLEXIBLE
- 1. THE PAVEMENT DESIGN AS DETAILED ASSUMES A PROPERLY PREPARED UNIFORM AND STABLE SUBGRADE. CONFIRMATION OF DESIGN CBR RATIO IS REQUIRED BY A GEOTECHNICAL ENGINEER PRIOR TO WORKS COMMENCING. 2. ASSUMED DESIGN CBR TO BE CONFIRMED ONSITE DURING
- CONSTRUCTION PRIOR TO PLACEMENT OF PAVEMENT MATERIALS THE CONTRACTOR IS TO UNDERTAKE SUFFICIENT CBR TESTING TO CONFIRM THE ASSUMED VALUE. WHERE A LESSER VALUE HAS BEEN DETERMINED, THE SUPERVISING ENGINEER IS TO BE NOTIFIED TO
- DETERMINE A REVISED PAVEMENT DESIGN. 3. PAVEMENT TO BE CONSTRUCTED AS FOLLOWS: - DENSE GRADED ASPHALT SURFACE COURSE PRIMERSEAL - EMULSION BASED HOT BITUMEN BASE COURSE - DGB 20
- SUB BASE - DGS 40 4. SUBGRADE SHALL BE COMPACTED TO 100% STANDARD MAXIMUM DRY DENSITY RATIO AT OPTIMUM MOISTURE CONTENT ±2%. IN
- ACCORDANCE WITH CURRENT AUSTRALIAN STANDARDS. 5. SUBBASE COURSE SHALL BE COMPACTED TO 95% MODIFIED
- MAXIMUM DRY DENSI 6. BASECOURSE SHALL BE COMPACTED TO 98% MODIFIED MAXIMUM
- DRY DENSITY. 7. PRIOR TO THE PLACEMENT OF THE PRIMERSEAL AND AFTER THE REQUIRED DENSITY IS ACHIEVED, THE PAVEMENT IS TO BE ALLOWED
- TO DRY BACK TO APPROXIMATELY 60% TO 70% OPTIMUM MOISTURE CONTENT 8. ALL SUBGRADES TO BE ROOF ROLLED & APPROVED BY SUPERVISING
- ENGINEER. 9. COMPACTION TESTS ARE TO BE UNDERTAKEN FOR ALL PAVEMENT LAYERS INCLUDING SUBGRADE AT A RATE TO BE DETERMINED BY THE SUPERVISING ENGINEER & THE RESULTS TO BE SUPPLIED TO THE ENGINEER PRIOR TO PLACEMENT OF THE NEXT PAVEMENT LAYER.

PAVEMENT - SEGMENTAL

- 1. THE PAVEMENT DESIGN AS DETAILED ASSUMES A PROPERLY PREPARED UNIFORM AND STABLE SUBGRADE. CONFIRMATION OF DESIGN CBR RATIO IS REQUIRED BY A GEOTECHNICAL ENGINEER PRIOR TO WORKS COMMENCING.
- 2. PREPARATION FOR PAVEMENT: CLEAR SITE, STRIP TOPSOIL, CUT AND FILL AND PREPARATION OF SUBGRADE SHALL BE AS
- DESCRIBED IN "EARTHWORKS". 3. SUBGRADE SHALL BE COMPACTED TO 98% STANDARD MAXIMUM DRY DENSITY AT OPTIMUM MOISTURE CONTENT ±2% IN ACCORDANCE WITH AS 1289.5.1.1.
- 4. BASECOURSE SHALL BE CONSTRUCTED FROM FINE CRUSHED ROCK DGB20 COMPACTED TO 100% STANDARD MAXIMUM DRY DENSITY AT OPTIMUM MOISTURE CONTENT ±2% IN ACCORDANCE WITH AS 1289.5.1.1.
- 5. PROVIDE CONCRETE WORKING SLAB 20MPa MIN 100mm THICK AS DETAILED ON DRAWING. 6. SEGMENTAL PAVING SHALL BE AS DETAILED ON THE DRAWINGS,
- AND ARE TO BE SUPPLIED WITH UNITS OF MAXIMUM GROSS PLAN AREA <0.1m². WHERE THIS AREA IS EXCEEDED REFER CONCRETE FLAG PAVEMENT SPECIFICATION.
- 7. ALL WORKMANSHIP AND MATERIALS FOR PAVER WORK SHALL BE IN ACCORDANCE WITH ALL AS 4455, AS4456, AS4459, T44, T45, T46. CURRENT EDITIONS WITH AMENDMENTS, EXCEPT WHERE VARIED BY THE CONTRACT DOCUMENT.

8. PAVER QUALITY:

APPLICATION	CHARACTERISTIC BREAKING LOAD (KN)	CHARACTERISTIC FLEXURAL STRENGTH (MPa)
RESIDENTIAL PEDESTRIAN	2	2
RESIDENTIAL DRIVEWAYS	5	3
PUBLIC FOOTPATHS	5	3
ROADS	5	3
INDUSTRIAL PAVEMENTS	10	4
PROJECT CONTROL TEST	ING SHALL BE CARR	IED OUT IN

ACCORDANCE WITH AS 4456.4 AND AS 4456.5. 9. PAVERS TO BE BEDDED AND SOUND EDGE RESTRAINTS ARE TO BE PROVIDED. JOINTS TO BE FULLY GROUTED.

No	DATE	DESCRIPTION	BY
1	18.08.22	ISSUED FOR DA	LTR
2	29.08.22	ISSUED FOR DA	LTR
3	15.09.22	ISSUED FOR DA	LTR
4	14.11.22	ISSUED FOR DA	LTR

CIVIL DRAWING LIST						
No.	SHEET NAME					
C001	NOTES & LEGEND					
C010	SITE PLAN					
C050	TYPICAL DETAILS					
C200	GROUND STORMWATER PLAN					
C210 LEVEL 1 STORMWATER PLAN						
C300	ROOF STORMWATER PLAN					






PROJECT PROPOSED SENIORS LIVING DEVELOPMENT

18-22 Mundamatta Street, VILLAWOOD NSW 2163


ADDRESS




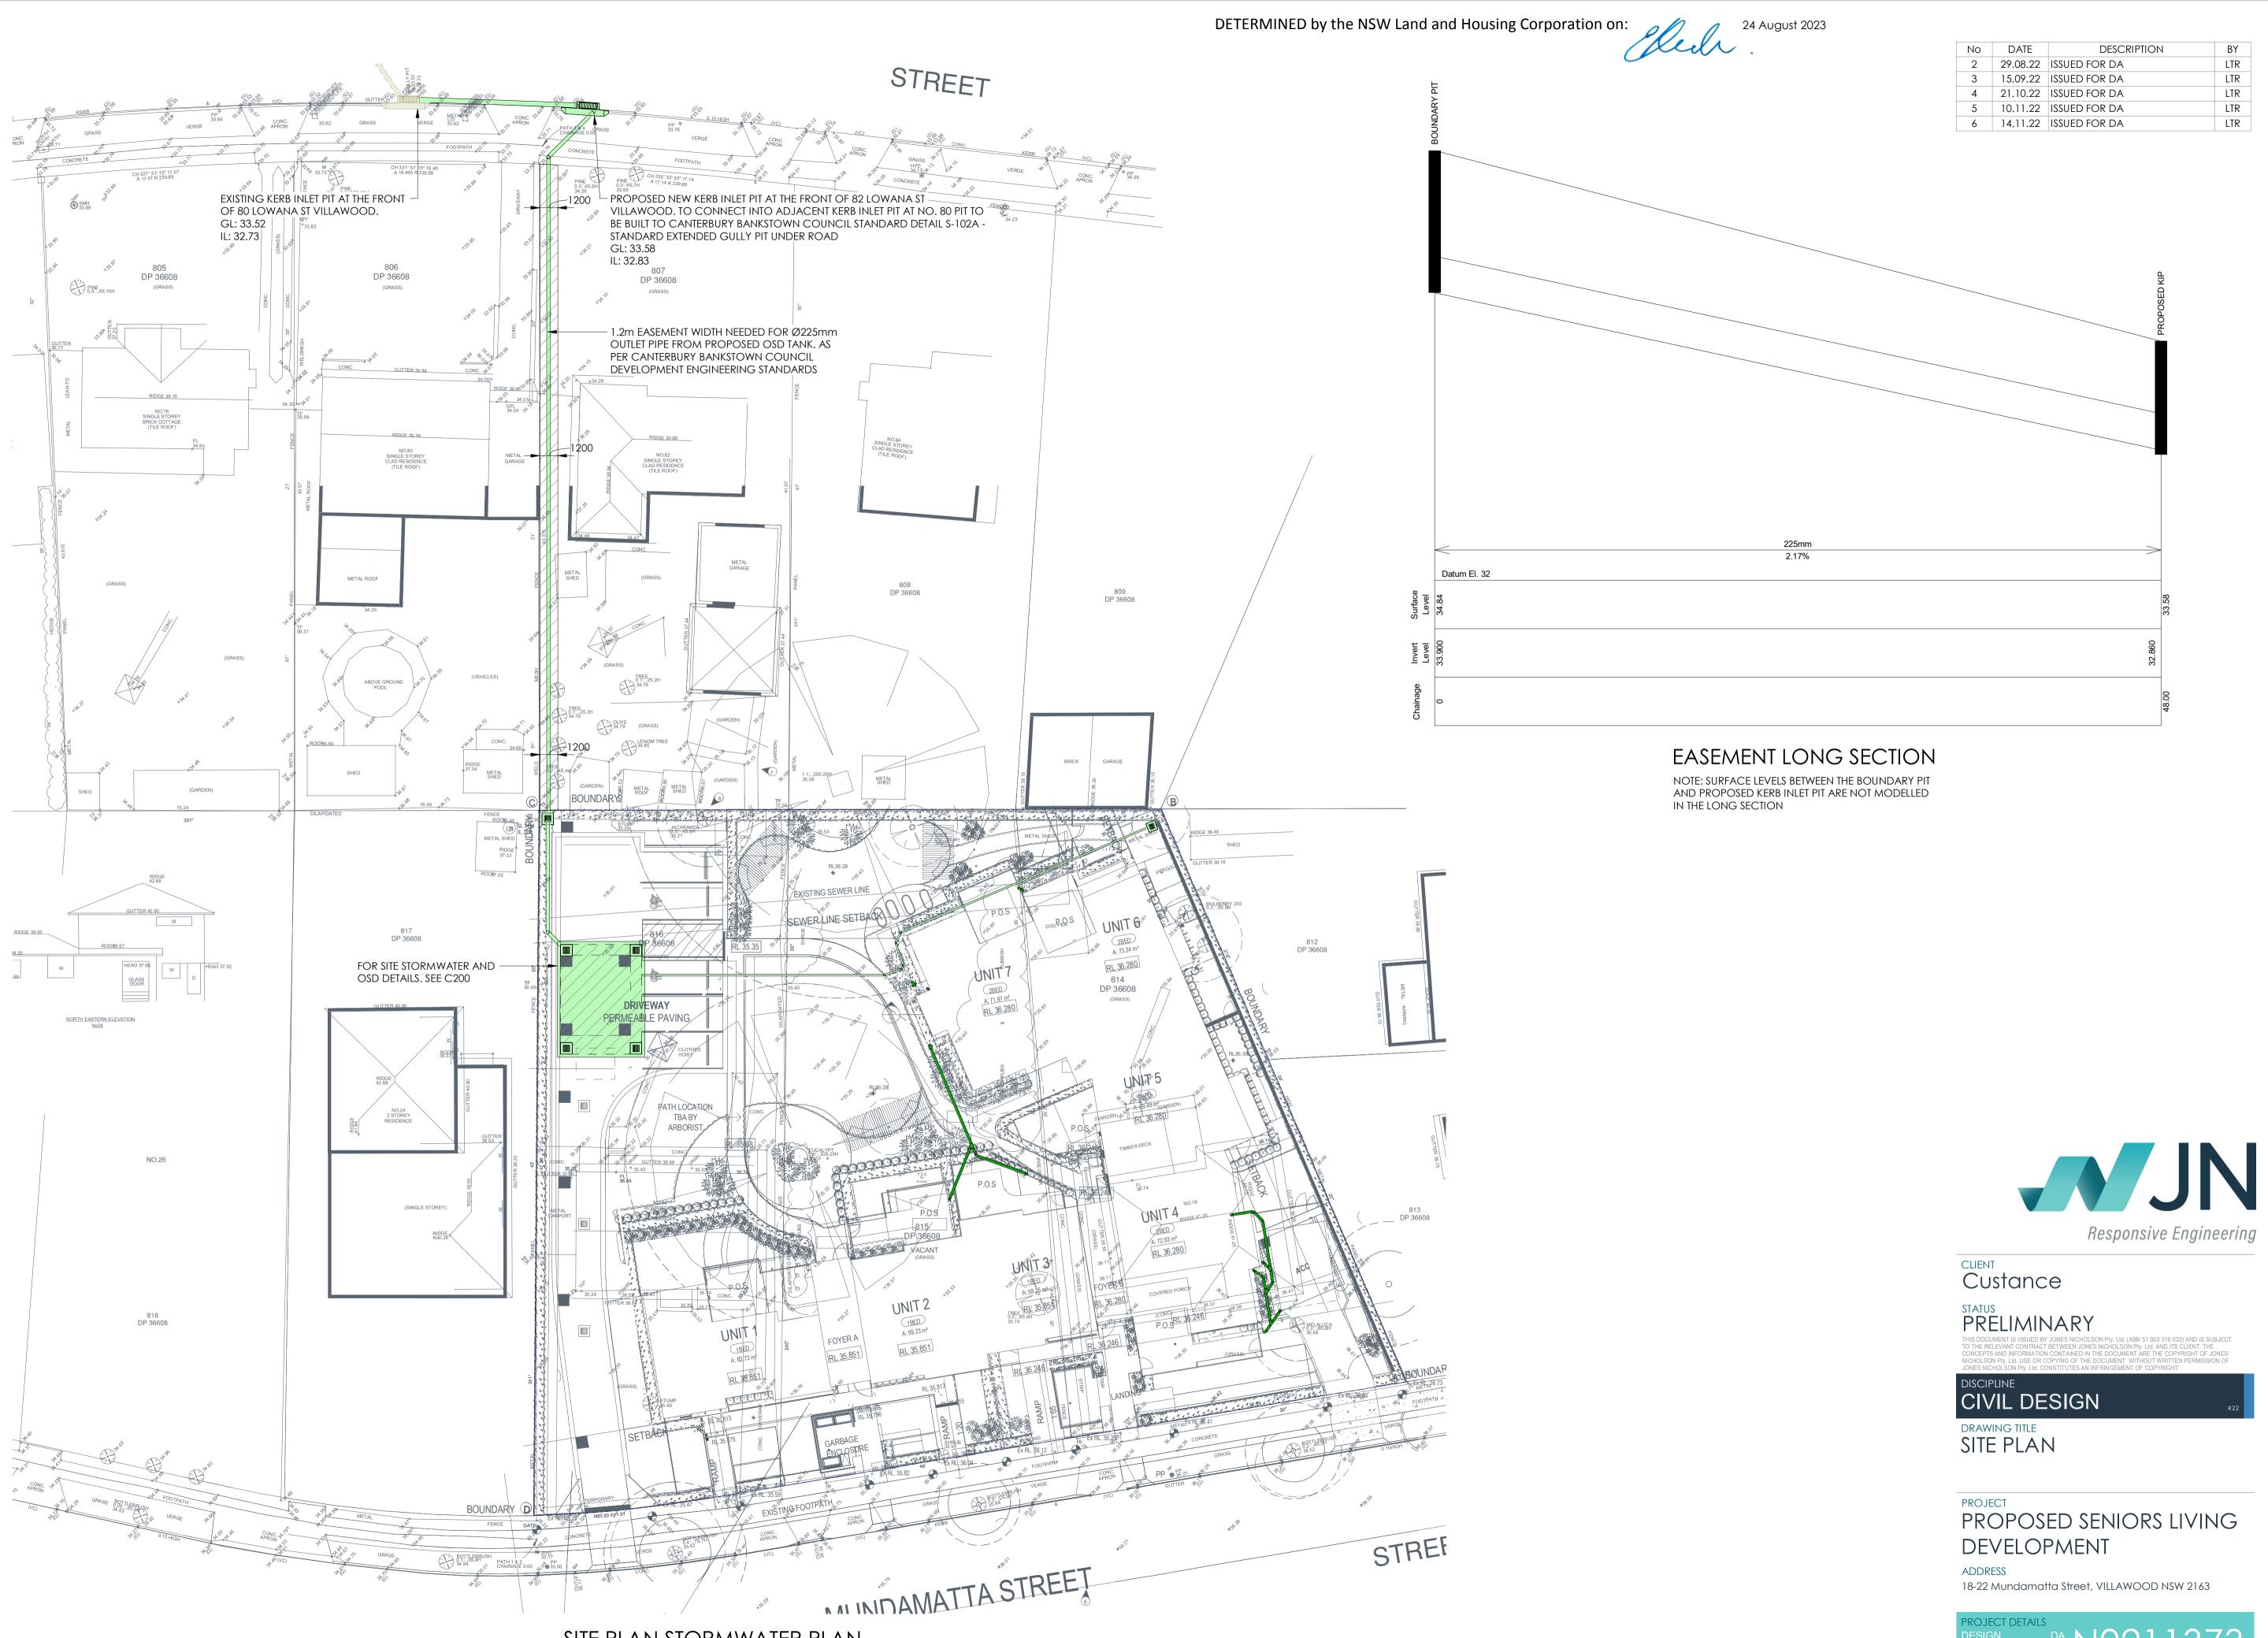

SITE PLAN STORMWATER PLAN SCALE 1:200




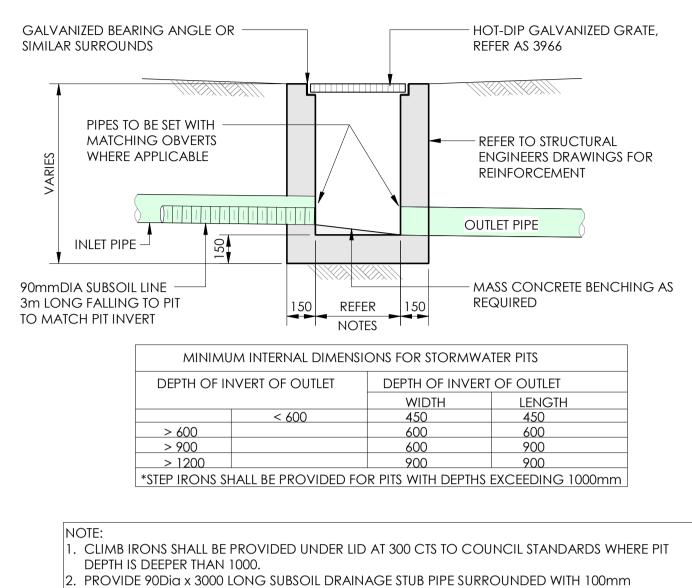

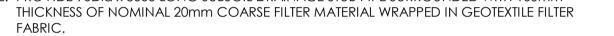


(BIDUM A24 OR APPROVED SIMILAR). TO BE PARALLEL TO UPSTREAM SIDE OF EACH INLET PIPE. 4. ALTERNATIVE PIT CONSTRUCTION MAY BE USED SUBJECT TO THE ENGINEERS APPROVAL. 5. CONCRETE STRENGTH F'C = 32 MPa



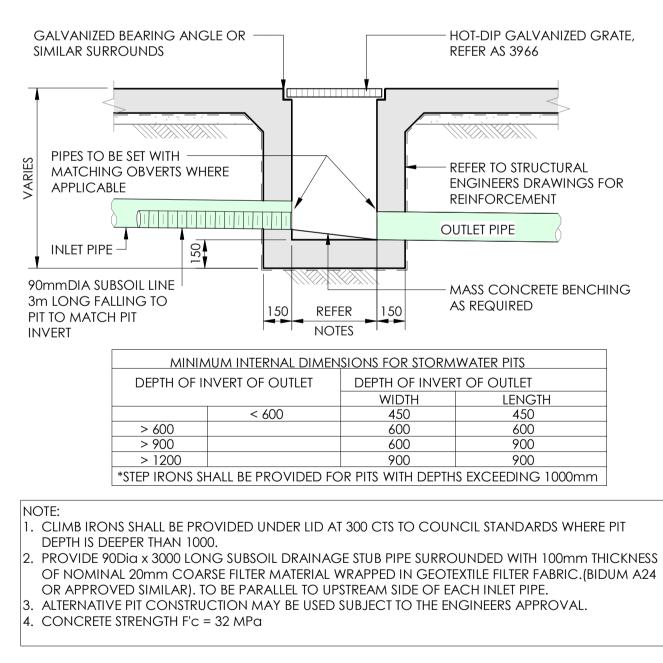



TYPICAL CONCRETE INLET PIT - CONCRETE SURFACE SCALE 1:20

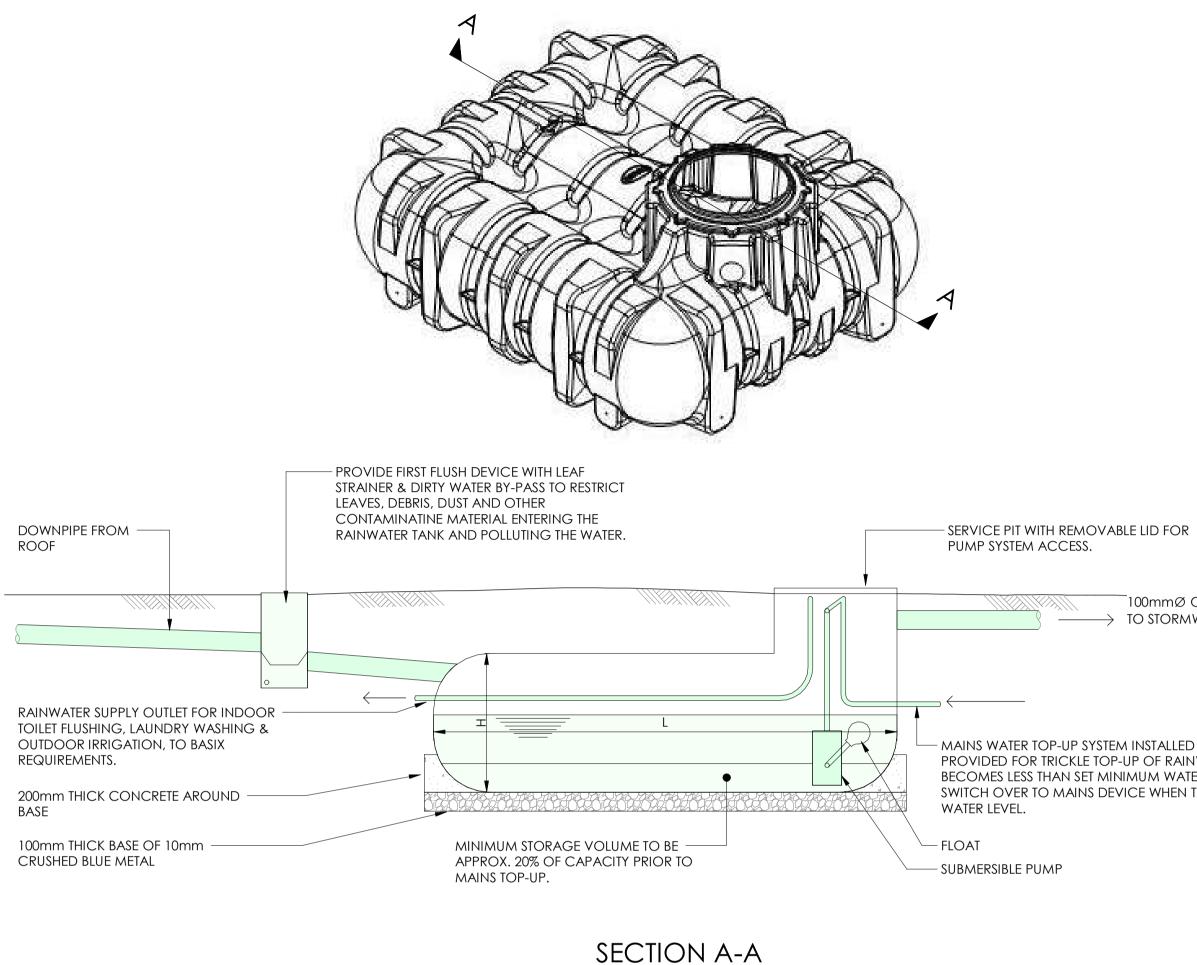

UNDERGROUND RAINWATER TANK DETAIL UNDERGROUND RAINWATER TANK. REFER BASIX REPORT FOR SIZING.

RAINWATER TANK - GRAF UNDER GROUND

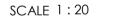

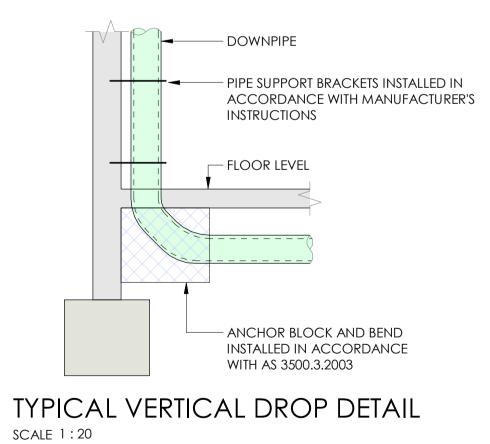



No	DATE	DESCRIPTION	BY
3	15.09.22	ISSUED FOR DA	LTR
4	21.10.22	ISSUED FOR DA	LTR
5	10.11.22	ISSUED FOR DA	LTR
6	14.11.22	ISSUED FOR DA	LTR
7	31.01.23	ISSUED FOR DA	LTR

100mmø overflow connected \longrightarrow TO STORMWATER SYSTEM.

- MAINS WATER TOP-UP SYSTEM INSTALLED TO AS/N25 3500.1 (2003) TO BE PROVIDED FOR TRICKLE TOP-UP OF RAINWATER TANK IF THE STORED WATER BECOMES LESS THAN SET MINIMUM WATER LEVEL. ALTERNATIVELY PROVIDE SWITCH OVER TO MAINS DEVICE WHEN TANK STORAGE REACHES MINIMUM





PROJECT PROPOSED SENIORS LIVING DEVELOPMENT

18-22 Mundamatta Street, VILLAWOOD NSW 2163

ADDRESS





DETERMINED by the NSW Land and Housing Corporation on:




No	DATE	DESCRIPTION	BY
5	10.11.22	ISSUED FOR DA	LTR
6	14.11.22	ISSUED FOR DA	LTR
7	23.11.22	ISSUED FOR DA	LTR
8	25.11.22	ISSUED FOR DA	LTR
9	31.01.23	ISSUED FOR DA	LTR

CONSULTANT, ARCHITECT AND LANDSCAPE





GROUND STORMWATER PLAN

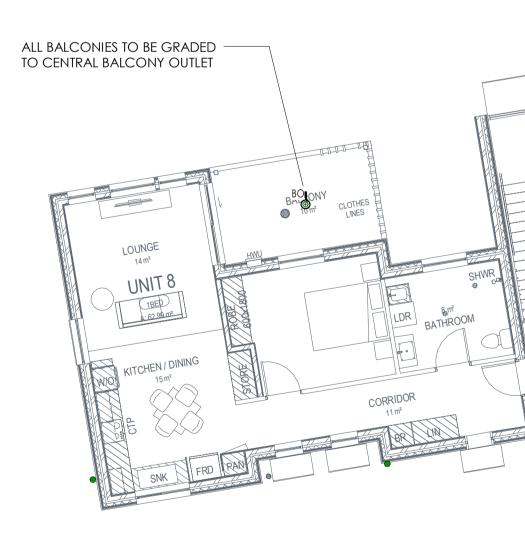



LEVEL 1 STORMWATER PLAN



No	DATE	DESCRIPTION	BY
1	18.08.22	ISSUED FOR DA	LTR
2	29.08.22	ISSUED FOR DA	LTR
3	15.09.22	ISSUED FOR DA	LTR
4	14.11.22	ISSUED FOR DA	LTR







STATUS PRELIMINARY

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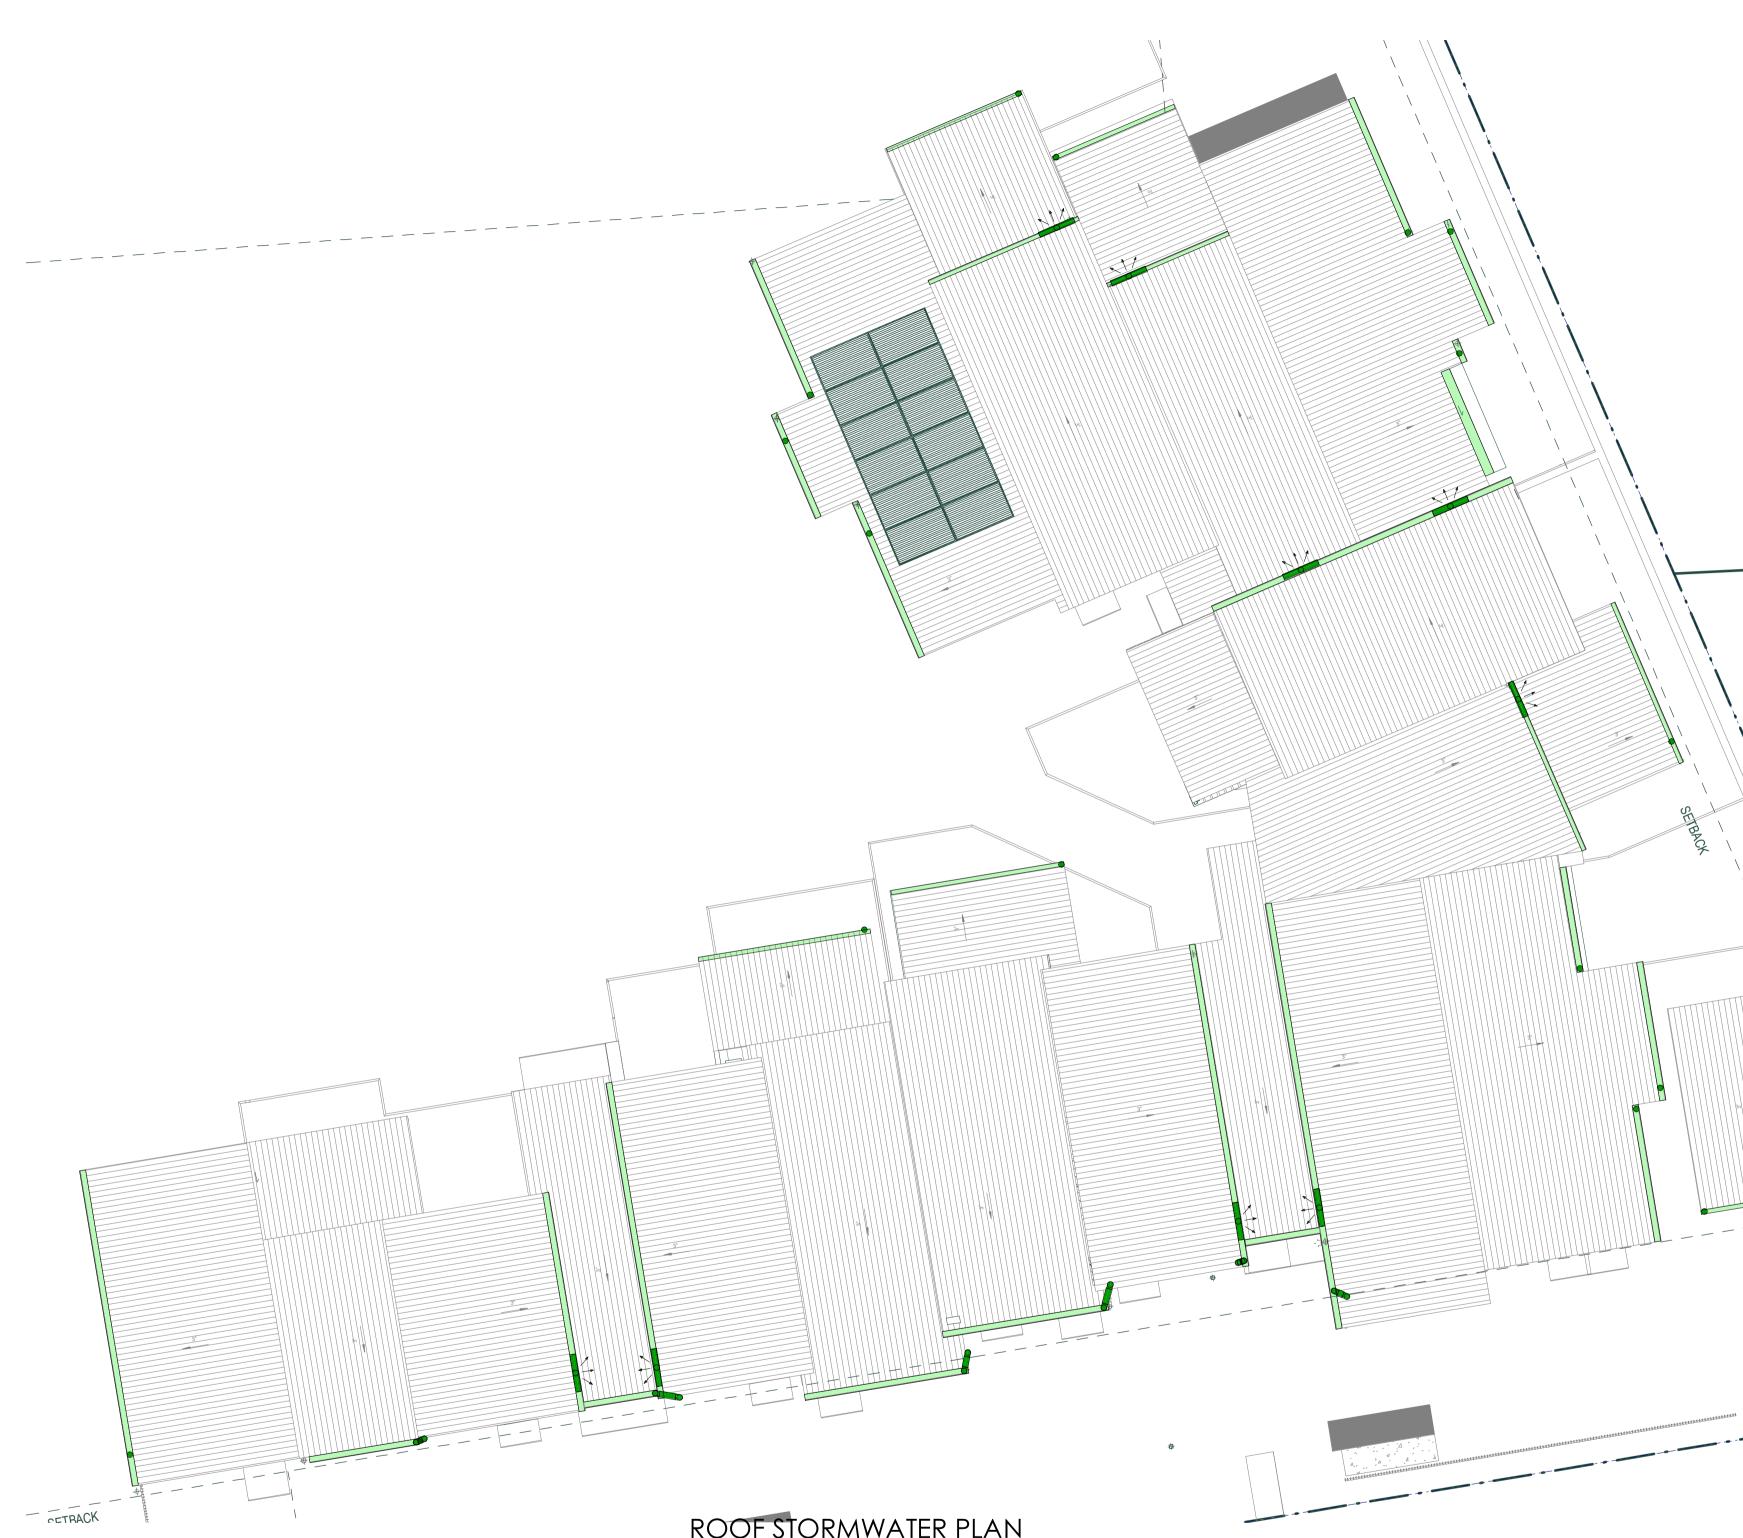
DISCIPLINE **CIVIL DESIGN**

DRAWING TITLE LEVEL 1 STORMWATER PLAN

PROJECT PROPOSED SENIORS LIVING DEVELOPMENT

ADDRESS 18-22 Mundamatta Street, VILLAWOOD NSW 2163






NOTES:

ROOF STORMWATER PLAN

• ALL GUTTERING TO BE EAVES GUTTERS ALL DOWNPIPE & DOWNPIPE SPREADER LOCATIONS AND QUANTITIES ARE INDICATIVE AND SUBJECT TO CHANGE IN DETAILED DESIGN DOWNPIPES EXPECTED TO RUN INTO RAINWATER TANK (OR MULTIPLE) FOR RE-USE VIA A CHARGED SYSTEM. PENDING JN COMPLETING BASIX REPORT REGARDING RWT REQUIREMENTS.

on:	le	ch
\mathcal{C}		- -

DATE	DESCRIPTION	BY
18.08.22	ISSUED FOR DA	LTR
14.11.22	ISSUED FOR DA	LTR
	18.08.22	DATE DESCRIPTION 18.08.22 ISSUED FOR DA 14.11.22 ISSUED FOR DA

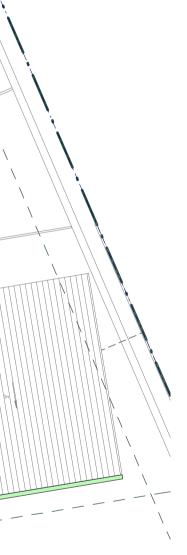



CLIENT Custance

ADDRESS

STATUS PRELIMINARY


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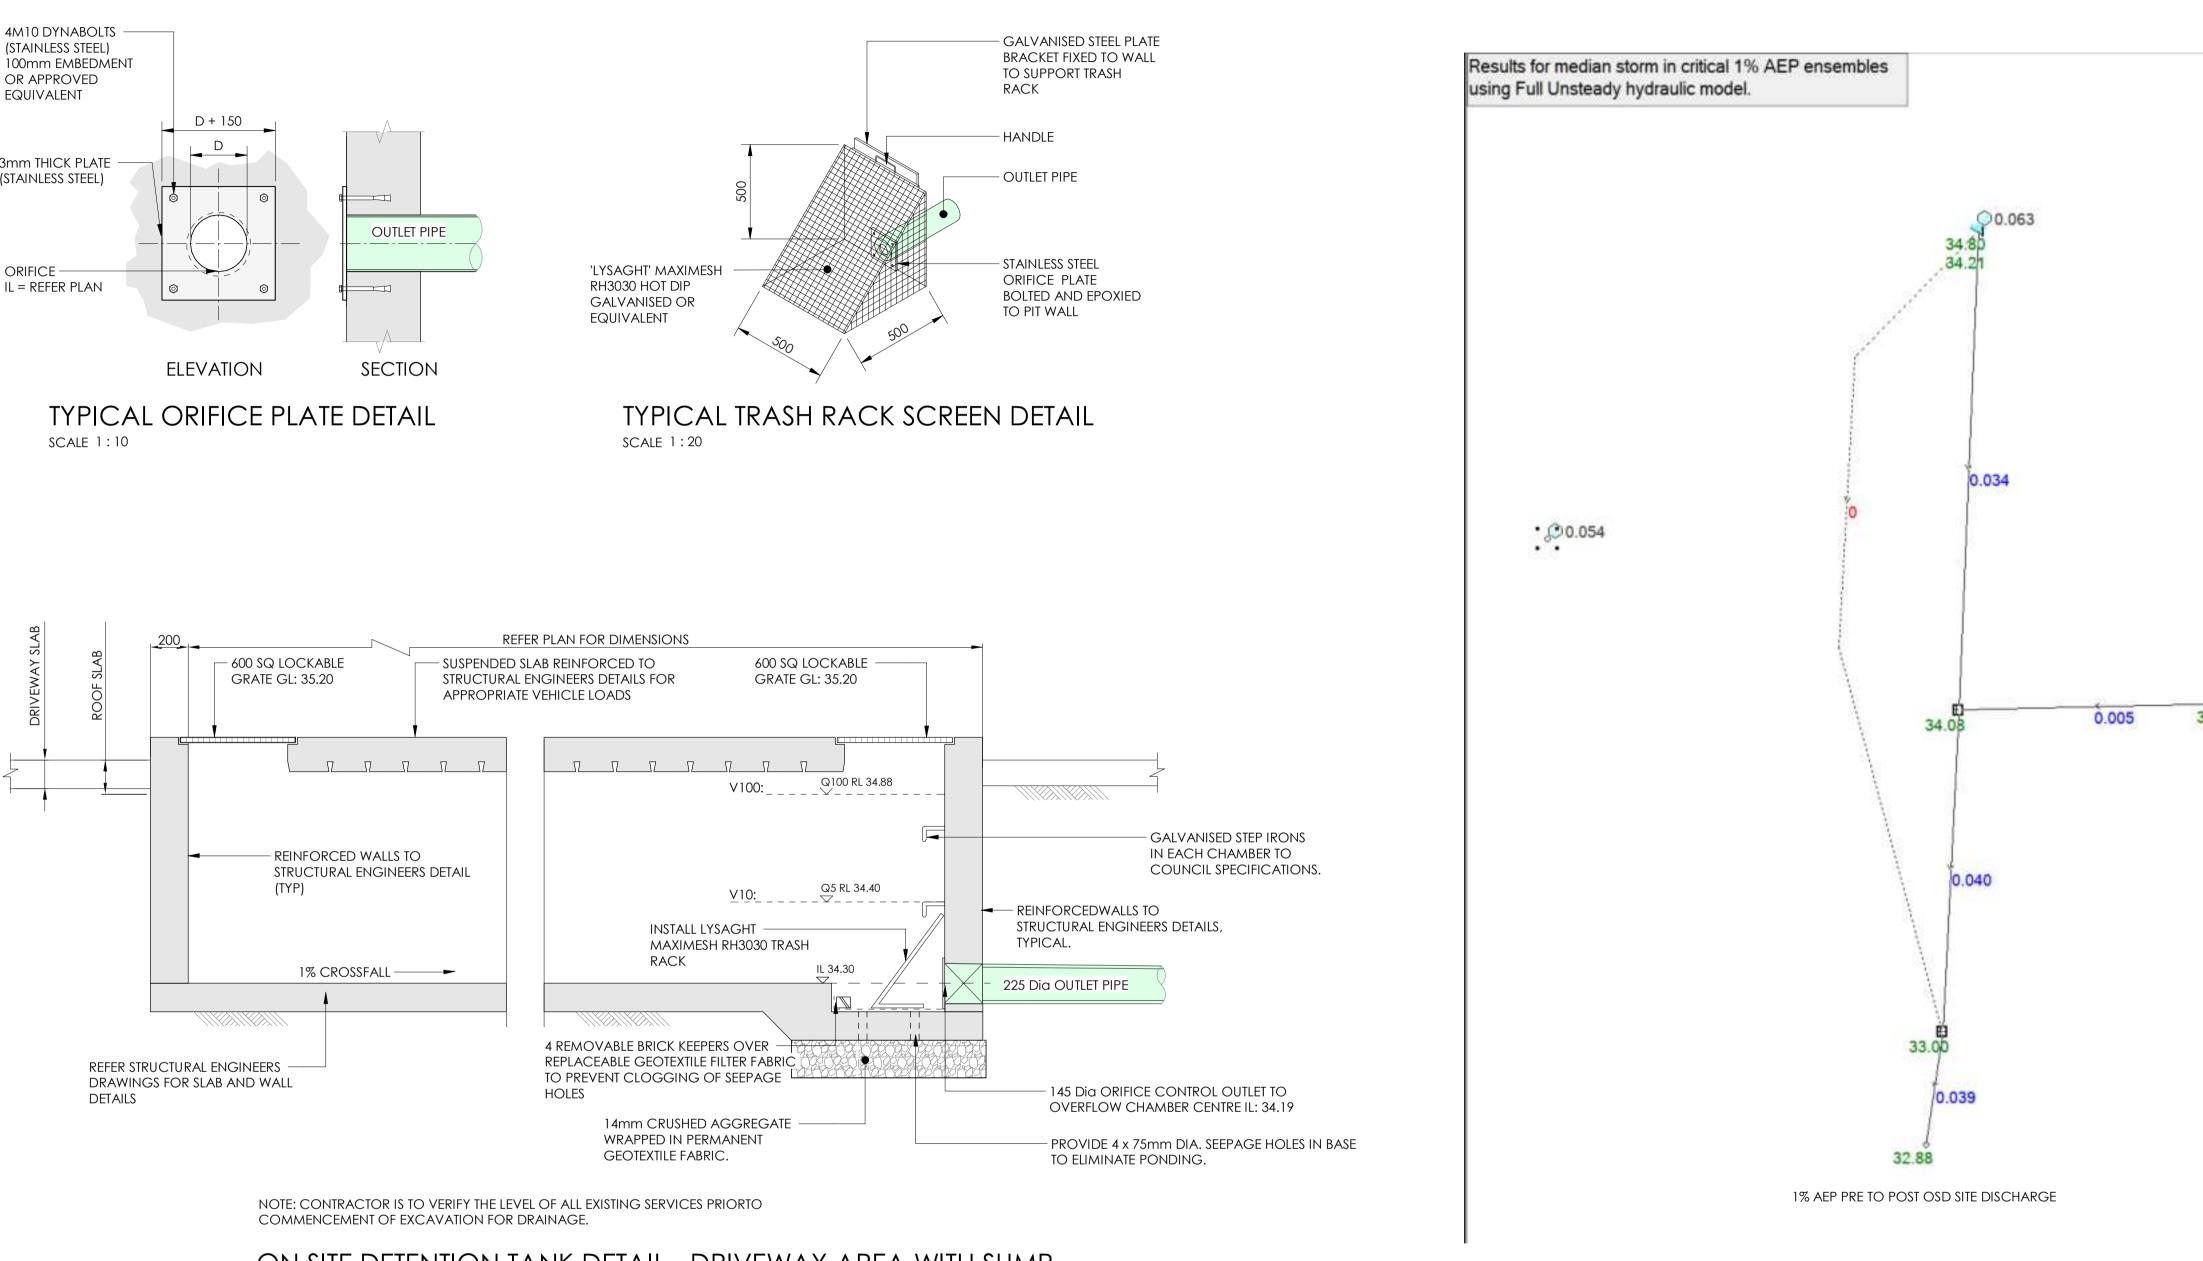
DRAWING TITLE ROOF STORMWATER PLAN

PROJECT PROPOSED SENIORS LIVING DEVELOPMENT

18-22 Mundamatta Street, VILLAWOOD NSW 2163





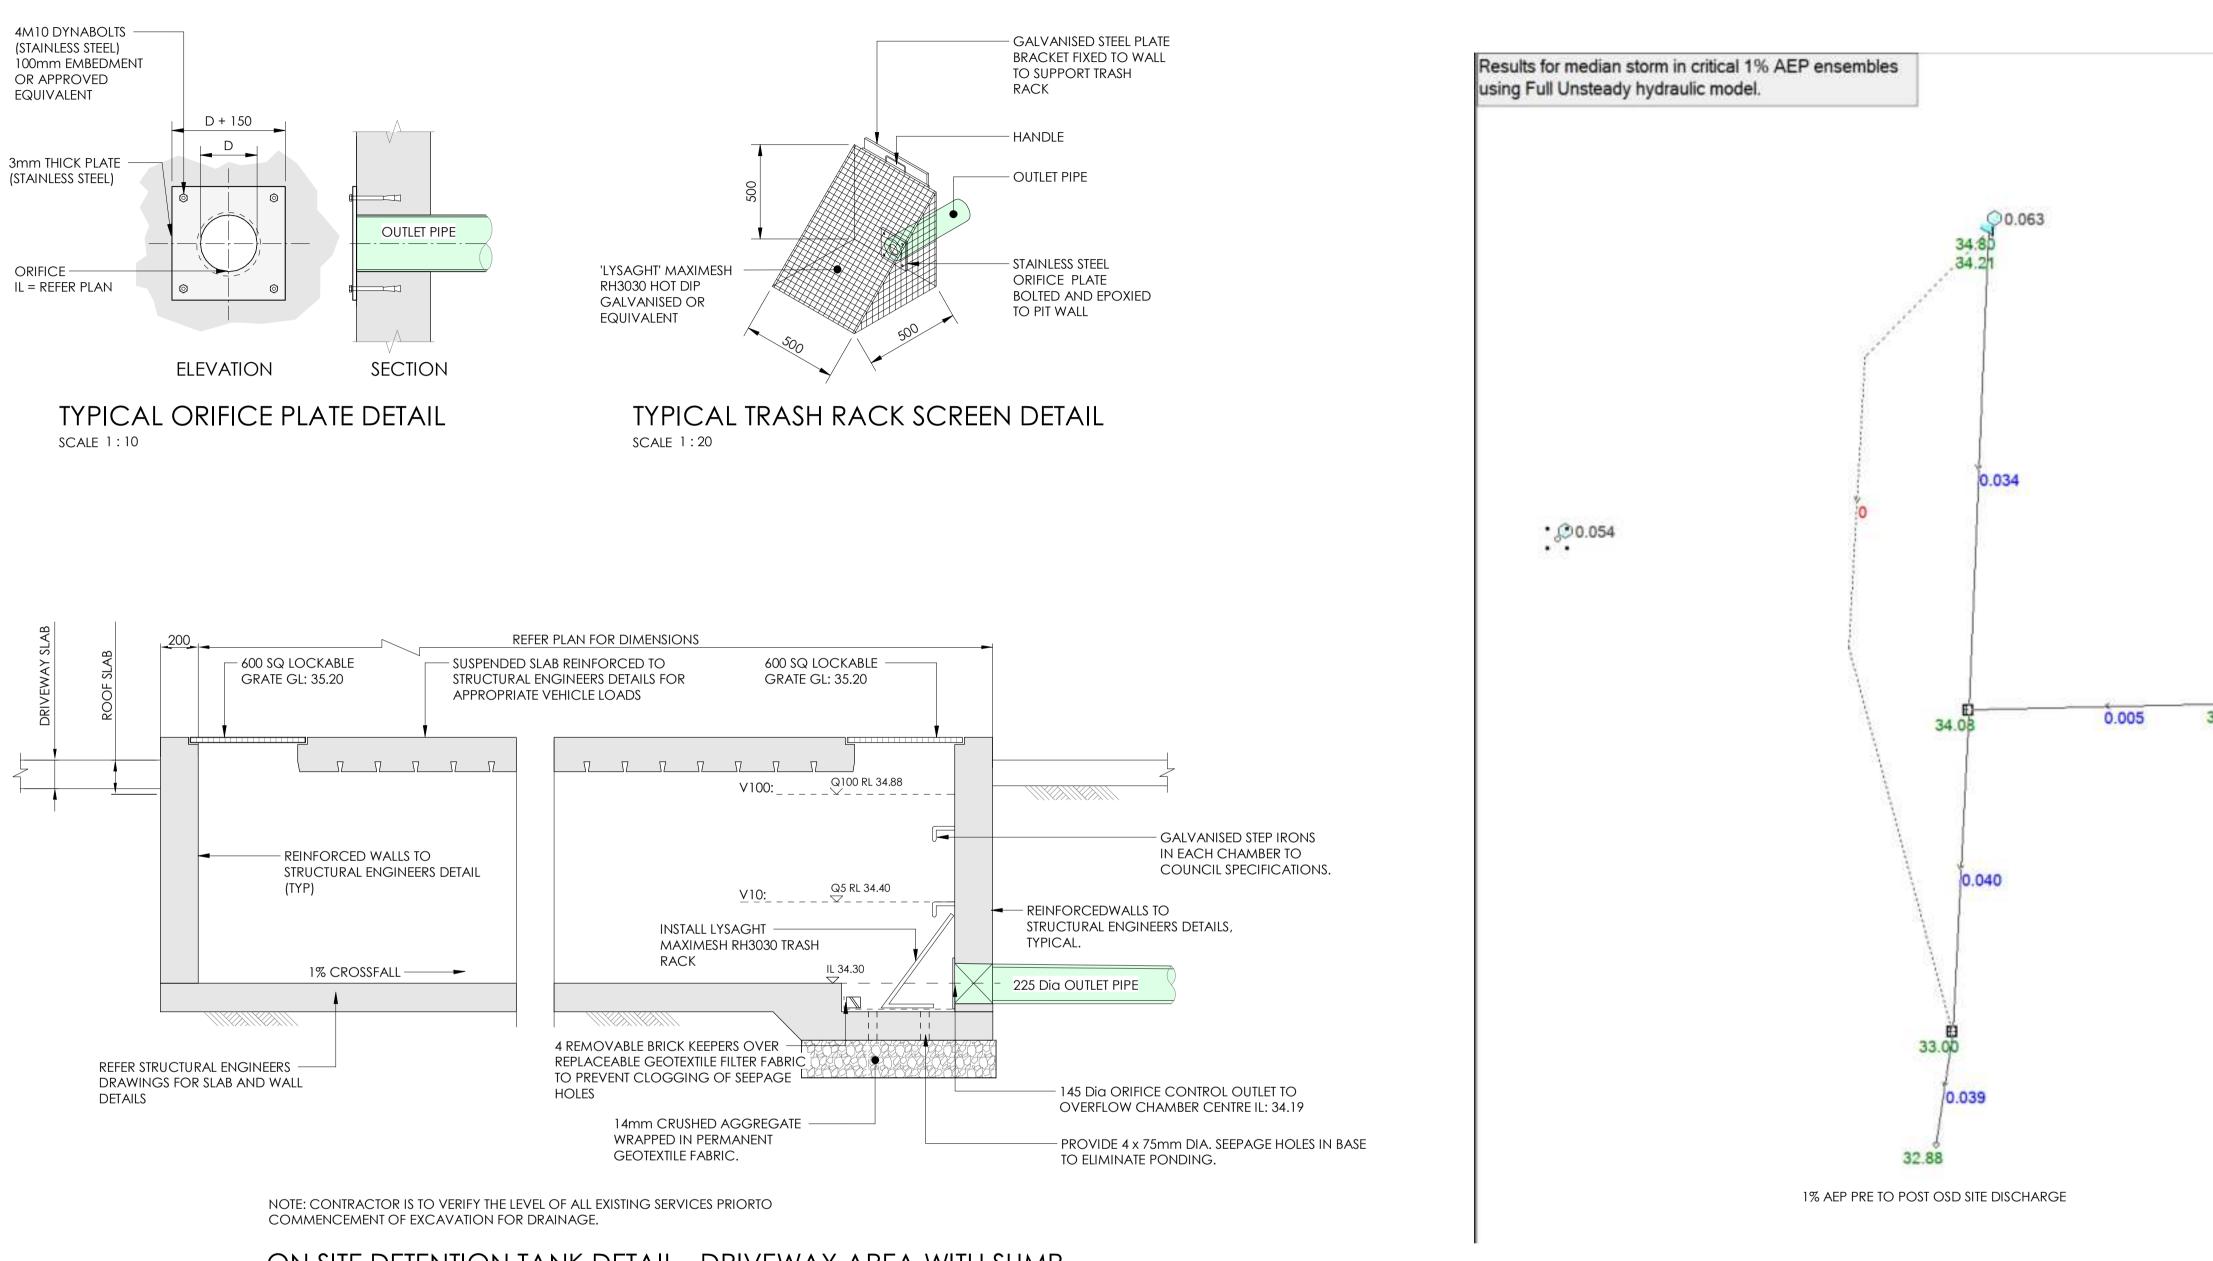

ON SITE DETENTION TANK DETAIL - DRIVEWAY AREA WITH SUMP SCALE 1:20

24 August 2023

No	DATE	DESCRIPTION	BY
1	31.01.23	ISSUED FOR DA	LTR
	1		







PROJECT PROPOSED SENIORS LIVING DEVELOPMENT ADDRESS

18-22 Mundamatta Street, VILLAWOOD NSW 2163



DETERMINED by the NSW Land and Housing Corporation on: 24

Bedr

24 August 2023

17 November 2022

Craig Shelsher



Our Ref: N0211373-CRPT.02A

Dear Craig,

Re: Cut & Fill DA Statement

 Project:
 LAHC development

 Client:
 Custance Associates Australia Pty Ltd

 Address:
 VILLAWOOD NSW 2163

 Australia

JN has reviewed an overlay with the survey and proposed ground floor plan and the cut & fill across site can be noted as minor cut or fill, less than 500mm. As seen in Appendix A, there are areas around Unit 2 & 3 (Green Area) that have fill of about 930mm to the finished floor level due to drops in height around the existing tree and access being provided from the footpath to the units. The 930mm fill level is taken from the survey level around the tree in Unit 3 and the finished floor level of the unit (fill will be less to the bottom of the unit slab).

Yours sincerely,

D. Alexander

Dylan Alexander Civil Design Engineer

jn.com.au


JONES NICHOLSON PTY LTD ABN: 51 003 316 032

BRISBANE GOLD COAST SINGLETON SOUTHERN HIGHLANDS SYDNEY-CBD SUTHERLAND WOLLONGONG GOULBURN




Appendix A – Cut & Fill Overlay




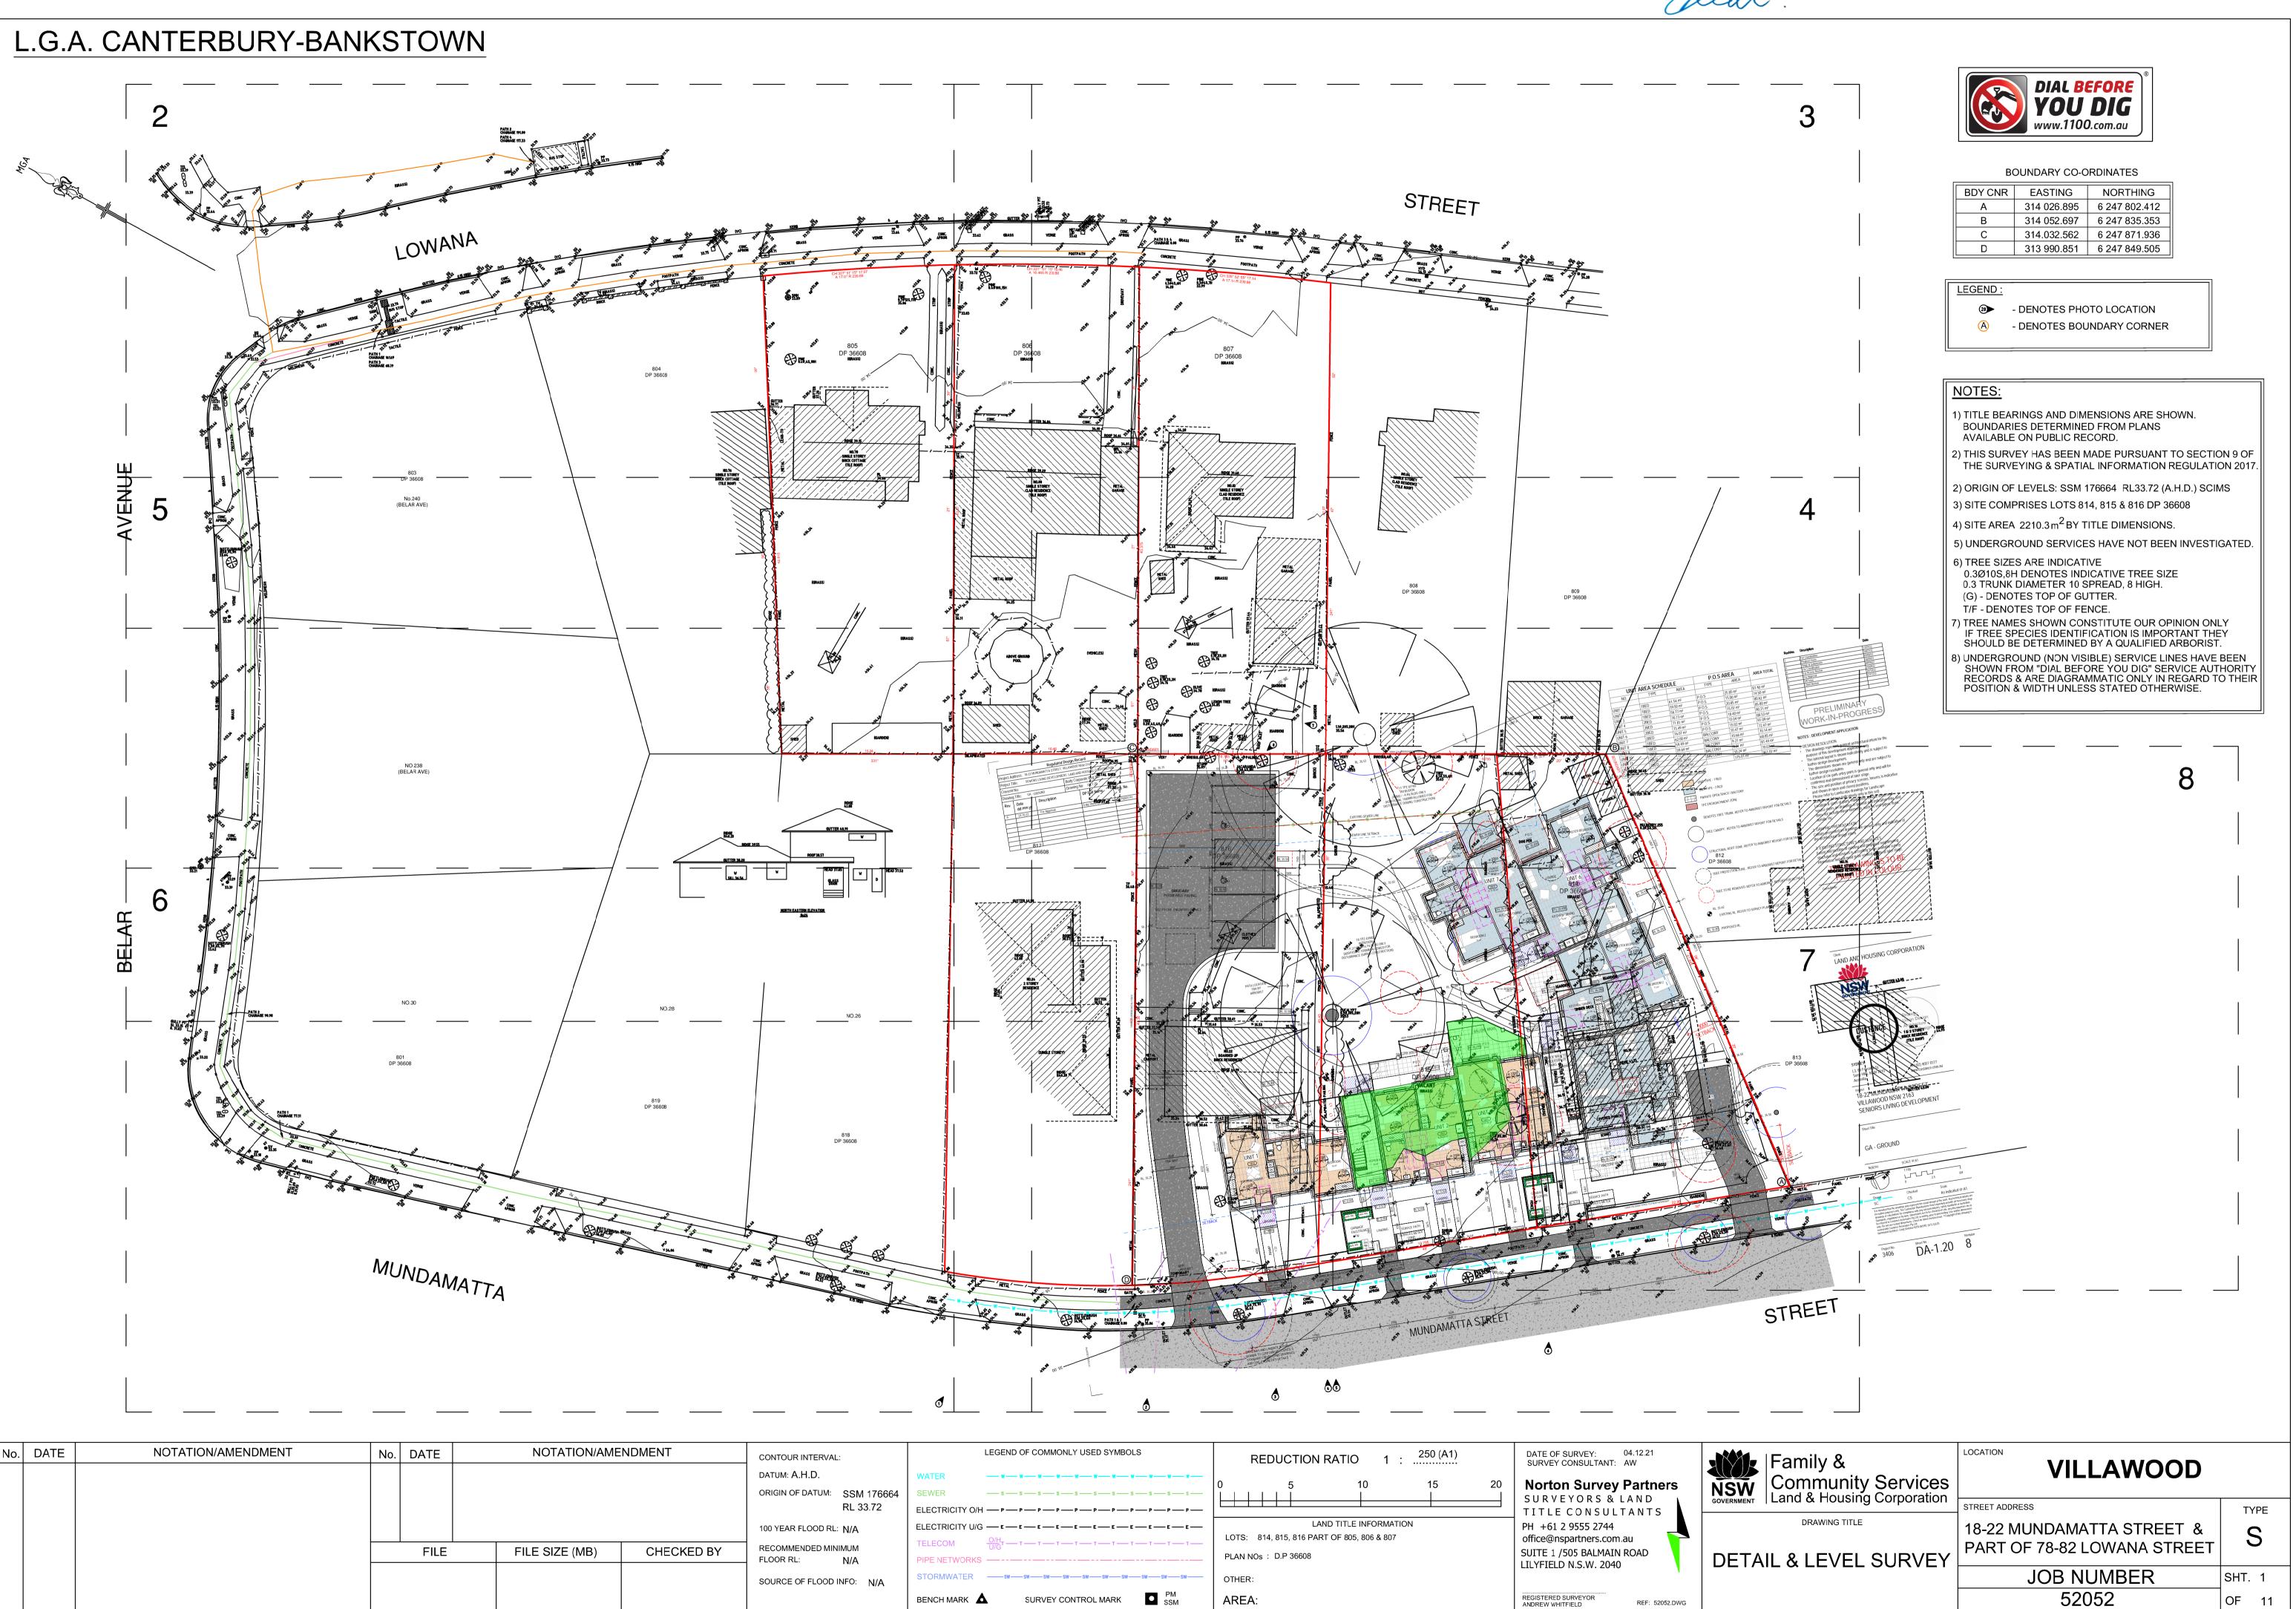


No.	DATE	NOTATION/AMENDMENT	No.	DATE	NOTATION/AME	NDMENT	CONTOUR INTERVAL:
							DATUM: A.H.D.
							ORIGIN OF DATUM: SS
							100 YEAR FLOOD RL: N/
				FILE	FILE SIZE (MB)	CHECKED BY	RECOMMENDED MINIMU
							SOURCE OF FLOOD INFO

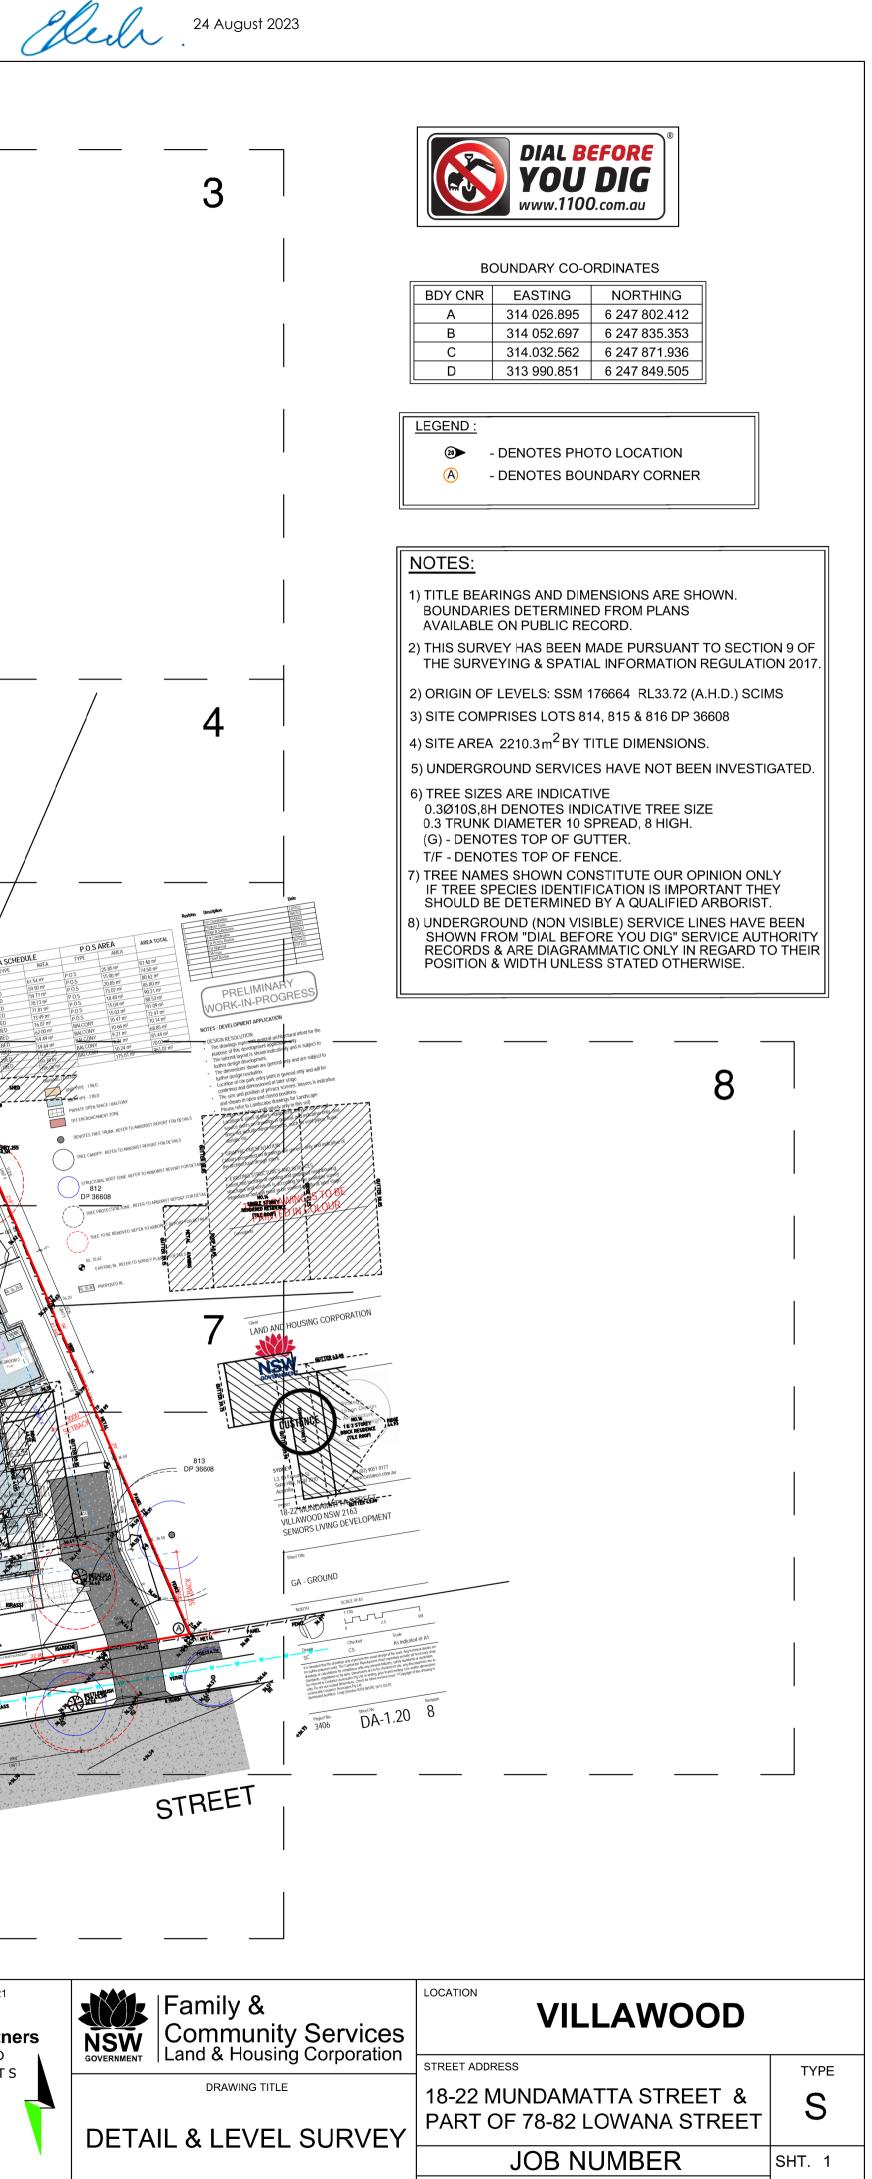

	1	REDUCTION RATIO 1 :	SURVEY CONSULTANT: AW
SSM 176664	WATER w <th></th> <th>Norton Survey Partners</th>		Norton Survey Partners
	ELECTRICITY O/H P P P P P P P P P P P P P P		TITLE CONSULTANTS
	ELECTRICITY U/G E	LAND TITLE INFORMATION LOTS: 814, 815, 816 PART OF 805, 806 & 807	PH +61 2 9555 2744 office@nspartners.com.au
-	PIPE NETWORKS	PLAN NOS : D.P 36608	SUITE 1 /505 BALMAIN ROAD LILYFIELD N.S.W. 2040
FO: N/A	STORMWATER	OTHER:	
	BENCH MARK SURVEY CONTROL MARK	AREA:	REGISTERED SURVEYOR ANDREW WHITFIELD REF: 52052.DWG

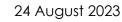

L.G.A. CANTERBURY-BANKSTOWN

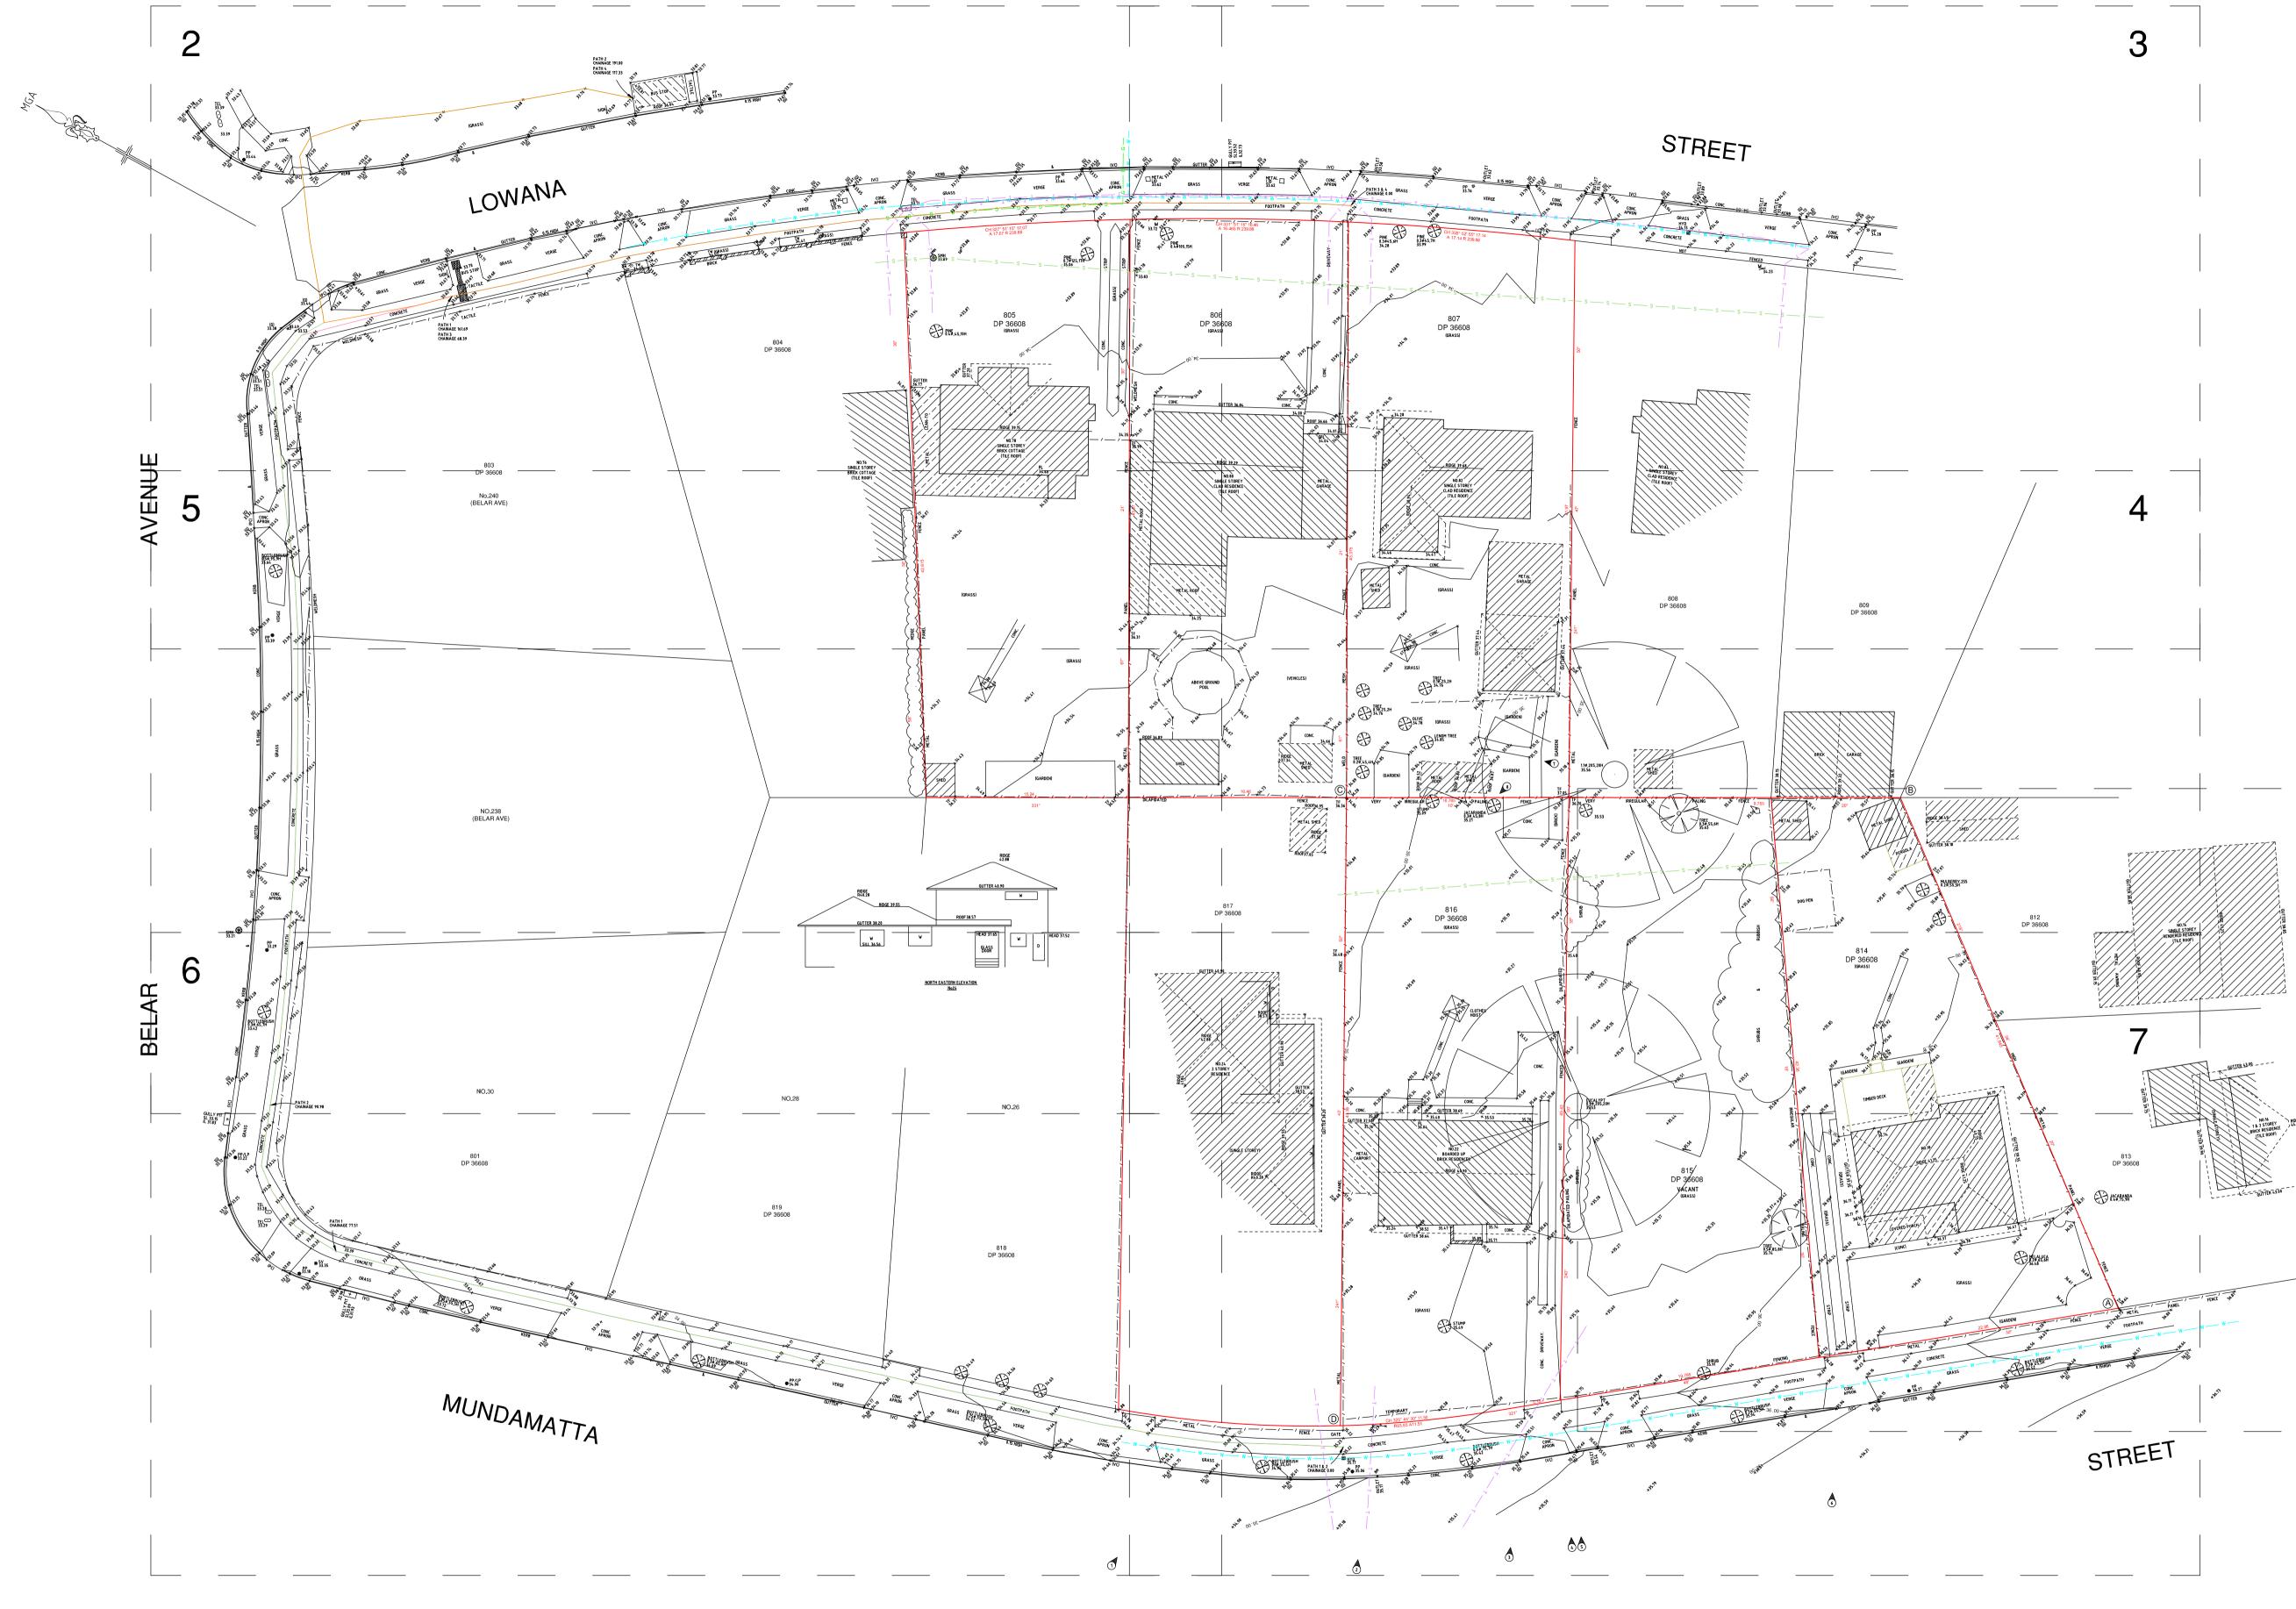

DATE	NOTATION/AMENDMENT	No.	DATE	NOTATION/AMENDMENT		CONTOUR INTERVAL:	
							DATUM: A.H.D.
							ORIGIN OF DATUM: SS
							RI
							100 YEAR FLOOD RL: N/
			FILE		FILE SIZE (MB)	CHECKED BY	RECOMMENDED MINIMU
							SOURCE OF FLOOD INFO
	DATE	DATE NOTATION/AMENDMENT	DATE NOTATION/AMENDMENT No.				

	LEGEND OF COMMONLY USED SYMBOLS WATER	REDUCTION RATIO 1 250 (A1) 0 5 10 15 20	DATE OF SURVEY: 04.12.21 SURVEY CONSULTANT: AW	
M 176664 33.72	SEWER		SURVEYORS & LAND TITLE CONSULTANTS	GOVERNI
Λ	ELECTRICITY U/G E	LOTS: 814, 815, 816 PART OF 805, 806 & 807 PLAN NOs : D.P 36608	PH +61 2 9555 2744 office@nspartners.com.au SUITE 1 /505 BALMAIN ROAD LILYFIELD N.S.W. 2040	DE
N/A	STORMWATER	OTHER: AREA:	REGISTERED SURVEYOR ANDREW WHITFIELD REF: 52052.DWG	



BOUNDARY CO-ORDINATES

BDY CNR	EASTING	NORTHING
А	314 026.895	6 247 802.412
В	314 052.697	6 247 835.353
С	314.032.562	6 247 871.936
D	313 990.851	6 247 849.505

LEGEND :

20	- DENOTES PHOTO LOCATION
A	- DENOTES BOUNDARY CORNER

NOTES:

- 1) TITLE BEARINGS AND DIMENSIONS ARE SHOWN. BOUNDARIES DETERMINED FROM PLANS AVAILABLE ON PUBLIC RECORD.
- 2) THIS SURVEY HAS BEEN MADE PURSUANT TO SECTION 9 OF THE SURVEYING & SPATIAL INFORMATION REGULATION 2017
- 2) ORIGIN OF LEVELS: SSM 176664 RL33.72 (A.H.D.) SCIMS 3) SITE COMPRISES LOTS 814, 815 & 816 DP 36608
- 4) SITE AREA 2210,3 m² BY TITLE DIMENSIONS. LOT 814 670.4m²
- LOT 815 763.9m² LOT 816 776.0m²
- 5) UNDERGROUND SERVICES HAVE NOT BEEN INVESTIGATED. 6) TREE SIZES ARE INDICATIVE
- 0.3Ø10S,8H DENOTES INDICATIVE TREE SIZE 0.3 TRUNK DIAMETER 10 SPREAD, 8 HIGH. (G) - DENOTES TOP OF GUTTER.
- T/F DENOTES TOP OF FENCE.
-) TREE NAMES SHOWN CONSTITUTE OUR OPINION ONLY IF TREE SPECIES IDENTIFICATION IS IMPORTANT THEY SHOULD BE DETERMINED BY A QUALIFIED ARBORIST.
- UNDERGROUND (NON VISIBLE) SERVICE LINES HAVE BEEN SHOWN FROM "DIAL BEFORE YOU DIG" SERVICE AUTHORITY RECORDS & ARE DIAGRAMMATIC ONLY IN REGARD TO THEIR POSITION & WIDTH UNLESS STATED OTHERWISE.

8





MUNDAMATTA STREET PERSPECTIVE



LOCKED BAG 5022 PARAMATTA NSW 2124 Phone No: 1300 305 695 ARCHITECT:

CUSTANCE



www.custance.com.au

NOTIFICATION PLANS SENIORS HOUSING 18-22 MUNDAMATTA STREET, VILLAWOOD NSW 2163

NOTIFICATION - COVER PAGE

18-22 MUNDAMATTA STREET, VILLAWOOD NSW 2163 LOTS 814-816 DP 36608



	NOTIFICATION PLANS SHEET LIST							
	SHEET NO		SHEET NAME	Current Revision	Current Descr		Current Revision Date	
	N-01	NOTIFIC	ATION - COVER PAGE	3	For Stage 5 Ap	proval	25/11/22	
	N-02	SITE / LA	NDSCAPE PLAN	3	For Stage 5 Ap	proval	25/11/22	
	N-03	ELEVATI	ONS	3	For Stage 5 Ap	proval	25/11/22	
	N-04	SHADOV	VS DIAGRAMS	3	For Stage 5 Ap	proval	25/11/22	
REV:			DATE:	PROJECT NO:		SHEET:		
3			25/11/22	BGYHY		N-01		
				©Convright of this	drawing is vested w	ith Custanoo A	seguiatos Australia Phylit	

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DETERMINED by the NSW Land and Housing Corporation on: 24 August 2023



	COMMON NAME	GHT (MATURE	SIZE	QT
		0	101 7	a.
	Mulga	6m	45LT	1
	Illawarra Flame Tree	10m	75LT	7
	Swamp Bloodwood	10m	75LT	1
	Silver Gum	15m	75LT	2
	Sandpaper Fig	6m	75LT	2
	White Oak	8m	75LT	2
	Snow in Summer	8m	100L	10
	Weeping Lily Pilly	10m	75LT	8
	Kangaroo Paw	1.8m	300mm	30
	Narrow-leaved Bottlebrush	2m	300mm	55
	Flax Lily	1m	300mm	62
	Spear Lily	2m	300mm	26
	Silver Turkeybush	2m	300mm	15
	Philip Island Hibiscus	3m	300mm	65
	Salt Bush	1m	300mm	55
	Spoon Leafed Strelitzia	1.5m	300mm	5
	Scrub Cherry	3m	300mm	30
	coastal rosemary	2m	300mm	16
9	Coastal Banksia	0.5m	140mm	12
	Native Daisy	0.3m	140mm	10
	Guinea Flower	0.5m	140mm	50
	French Lavender	1m	200mm	50
iant'	Giant liriope	0.5m	200mm	25
	Tanika	0.4m	140mm	75
	Creeping Boobialla	0.2m	140mm	20
es	Star Jasmine	_	140mm	72
	Native Violet	0.2m	140mm	20
		0.5m	140mm	11



KEY PLAN

DESIGN NOTES:

- 01) EXISTING TREES TO BE RETAINED
- (02) FEATURE TREE TO FRONT COURTYARD
- (03) GRAVEL TRIM TO BUILDING
- (04) SCREEN PLANTING TO BOUNDARY
- 05 VEGETABLE GARDEN
- (06) SEATING WITH PERGOLAR
- 07) OPEN TURF FOR MULTIPLE ACTIVITY
- (08) ROOF STRUCTURE OVER CARPARK



FENCE TO FRONTAGE

25/11/22

REE	20.0 18.5 × EX 18.25 +RL 20.0	EXISTING CON PROPOSED NI EXISTING SPC PROPOSED SF	EW CONTOUR DT LEVEL	TO	nm WIDE GRAVEL TRIM BUILDING PPOSED SHRUBS	Constraints	PROPOSED GROUNDCOVERS CONCRETE UNIT PAVERS BY BORAL, 400mm SQUARE	
REV:			DATE:		PROJECT NO:		SHEET:	

BGYHY

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N-02



SOUTH ELEVATION - MUNDAMUTTA STREET



EAST ELEVATION 2



NORTH ELEVATION 2



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ARCHITECT:



18-22 MUNDAMATTA STREET, VILLAWOOD NSW 2163 LOTS 814-816 DP 36608

ELEVATIONS

WEST ELEVATION 2

9.5M HEIGHT LINE



NORTH ELEVATION 1

WEST ELEVATION 1





PROPOSED DEVELOPMENT DATA - SEPP HOUSING 2021						
Site Area	2210.36 m ²					
Number of dwellings	12 units (7 x 1 Bed + 5 x 2 Beds)					
	Control	Requirement	Proposed			
Front Setback	Canterbury Bankstown Council	5.5m	5.5m			
Side Setback	Canterbury Bankstown Council	3 m	3 m			
Rear Setback	Canterbury Bankstown Council	Set by Sewerline and easement	Set by Sewerline and easement			
Height	SEPP Housing 2021	9.5m building height (top of ridge)	7.2m building height (top of ridge)			
Floor Space Ratio	SEPP Housing 2021	0.5 : 1	0.36:1			
	Canterbury Bankstown Council	N/A	N/A			
Landscape	SEPP Housing 2021	35m2 per unit = 420m2.	950 m2			
Deep Soil Zone 15% of site with minimum dimensions of 3m	SEPP Housing 2021	331.5 m2	583 m2			
65% of this at rear	SEPP Housing 2021	378.95 m2	488 m2			
70% of dwellings to have three hours sunlight to living areas and to associated private open space	SEPP Housing 2021	9	10 83% of development			
Parking	SEPP Housing 2021	0.4 spaces / 1 bed (7) = 2.8 0.5 spaces / 2bed (5) = 2.5 TOTAL SPACES = 6	6 spaces: 2 Accessible spaces with common shared area 1 separate dedicated Accessible space 3 standard spaces			

Note: Refer to DA-11.00 for GFA definitions and calculations



1:100 2.5 0 5M SCALE @ A1

REV:	DATE:	PROJECT NO:	SHEET:
3	25/11/22	BGYHY	N-03

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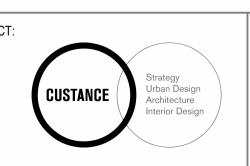


SHADOW DIAGRAMS AT 3PM (21 JUNE)



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ARCHITECT:



SHADOWS DIAGRAMS

18-22 MUNDAMATTA STREET, VILLAWOOD NSW 2163 LOTS 814-816 DP 36608

1:100 0 2.5 SCALE @ A1

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3	25/11/22	BGYHY	N-04

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